PERMITTING DRAWINGS

FOR

LOT 22 LIBBY HILL BUSINESS PARK GARDINER, MAINE

JULY 2022



PROFESSIONAL CONTACTS:

<u>APPLICANT :</u> GARDINER TRANSFER

GARDINER TRANSFER COMPANY, LLC

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ENGINEERING & DESIGN:

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CONTACT: KYLE JACOBSON, PE#16656 CONTACT: ELLEN RATHBONE

SURVEYOR:

BOUNDARY ENGINEERING SURVEY TECHNOLOGY

25 TUBROS LANE

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WETLAND SCIENTIST:

STANTEC 30 PARK DRIVE TOPSHAM, ME 04086 (207) 406-5496

CONTACT: TOM TETREAU, NHCWS#283, PWS

DRAWING LIST:

C-001 COVER SHEET

--- EXISTING CONDITIONS SURVEY C-101 EXISTING CONDITIONS PLAN

C-102 SITE PLAN

C-103 GRADING, DRAINAGE, UTILITIES, & EROSION CONTROL PLAN
C-104 GRADING, DRAINAGE, UTILITIES, & EROSION CONTROL PLAN

C-105 GRAVEL WETLAND PLAN


C-501 EROSION & SEDIMENTATION CONTROL NOTES & DETAILS

C-502 DETAILS C-503 DETAILS

C-701 PRE-DEVELOPMENT DRAINAGE PLAN
C-702 POST-DEVELOPMENT DRAINAGE PLAN

- SITE LIGHTING LAYOUT

A-101 PROPOSED BUILDING ELEVATIONS

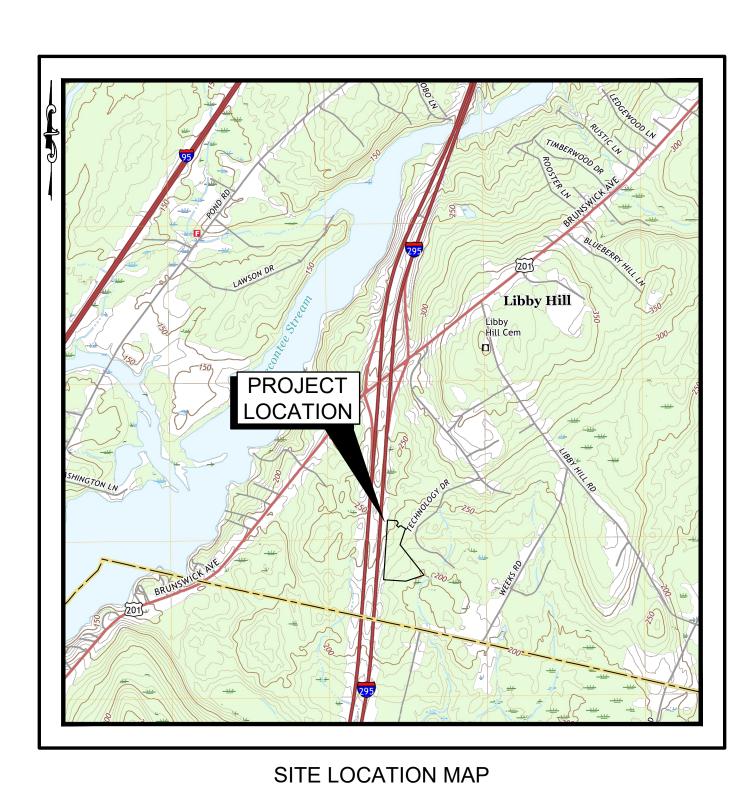

SCALE: 1" = 2,000'±
SOURCE: USGS, GARDINER, MAINE, QUADRANGLE, DATED 2018





REV.	DATE	REVISION DESCRIPTION

DESIGNED BY:

DRAWN BY:

CHECKED BY:

DATE:

7/20/2022

FILE NAME:

1172-0002 COV02.dwg

PROJECT NAME

LOT 22 LIBBY HILL BUSINESS PARK 12 TROIANO WAY GARDINER, MAINE


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GARDINER TRANSFER COMPANY, LLC PO BOX 3541 PORTLAND, MAINE

SHEET TITLE:

COVER SHEET

SHEET NO:

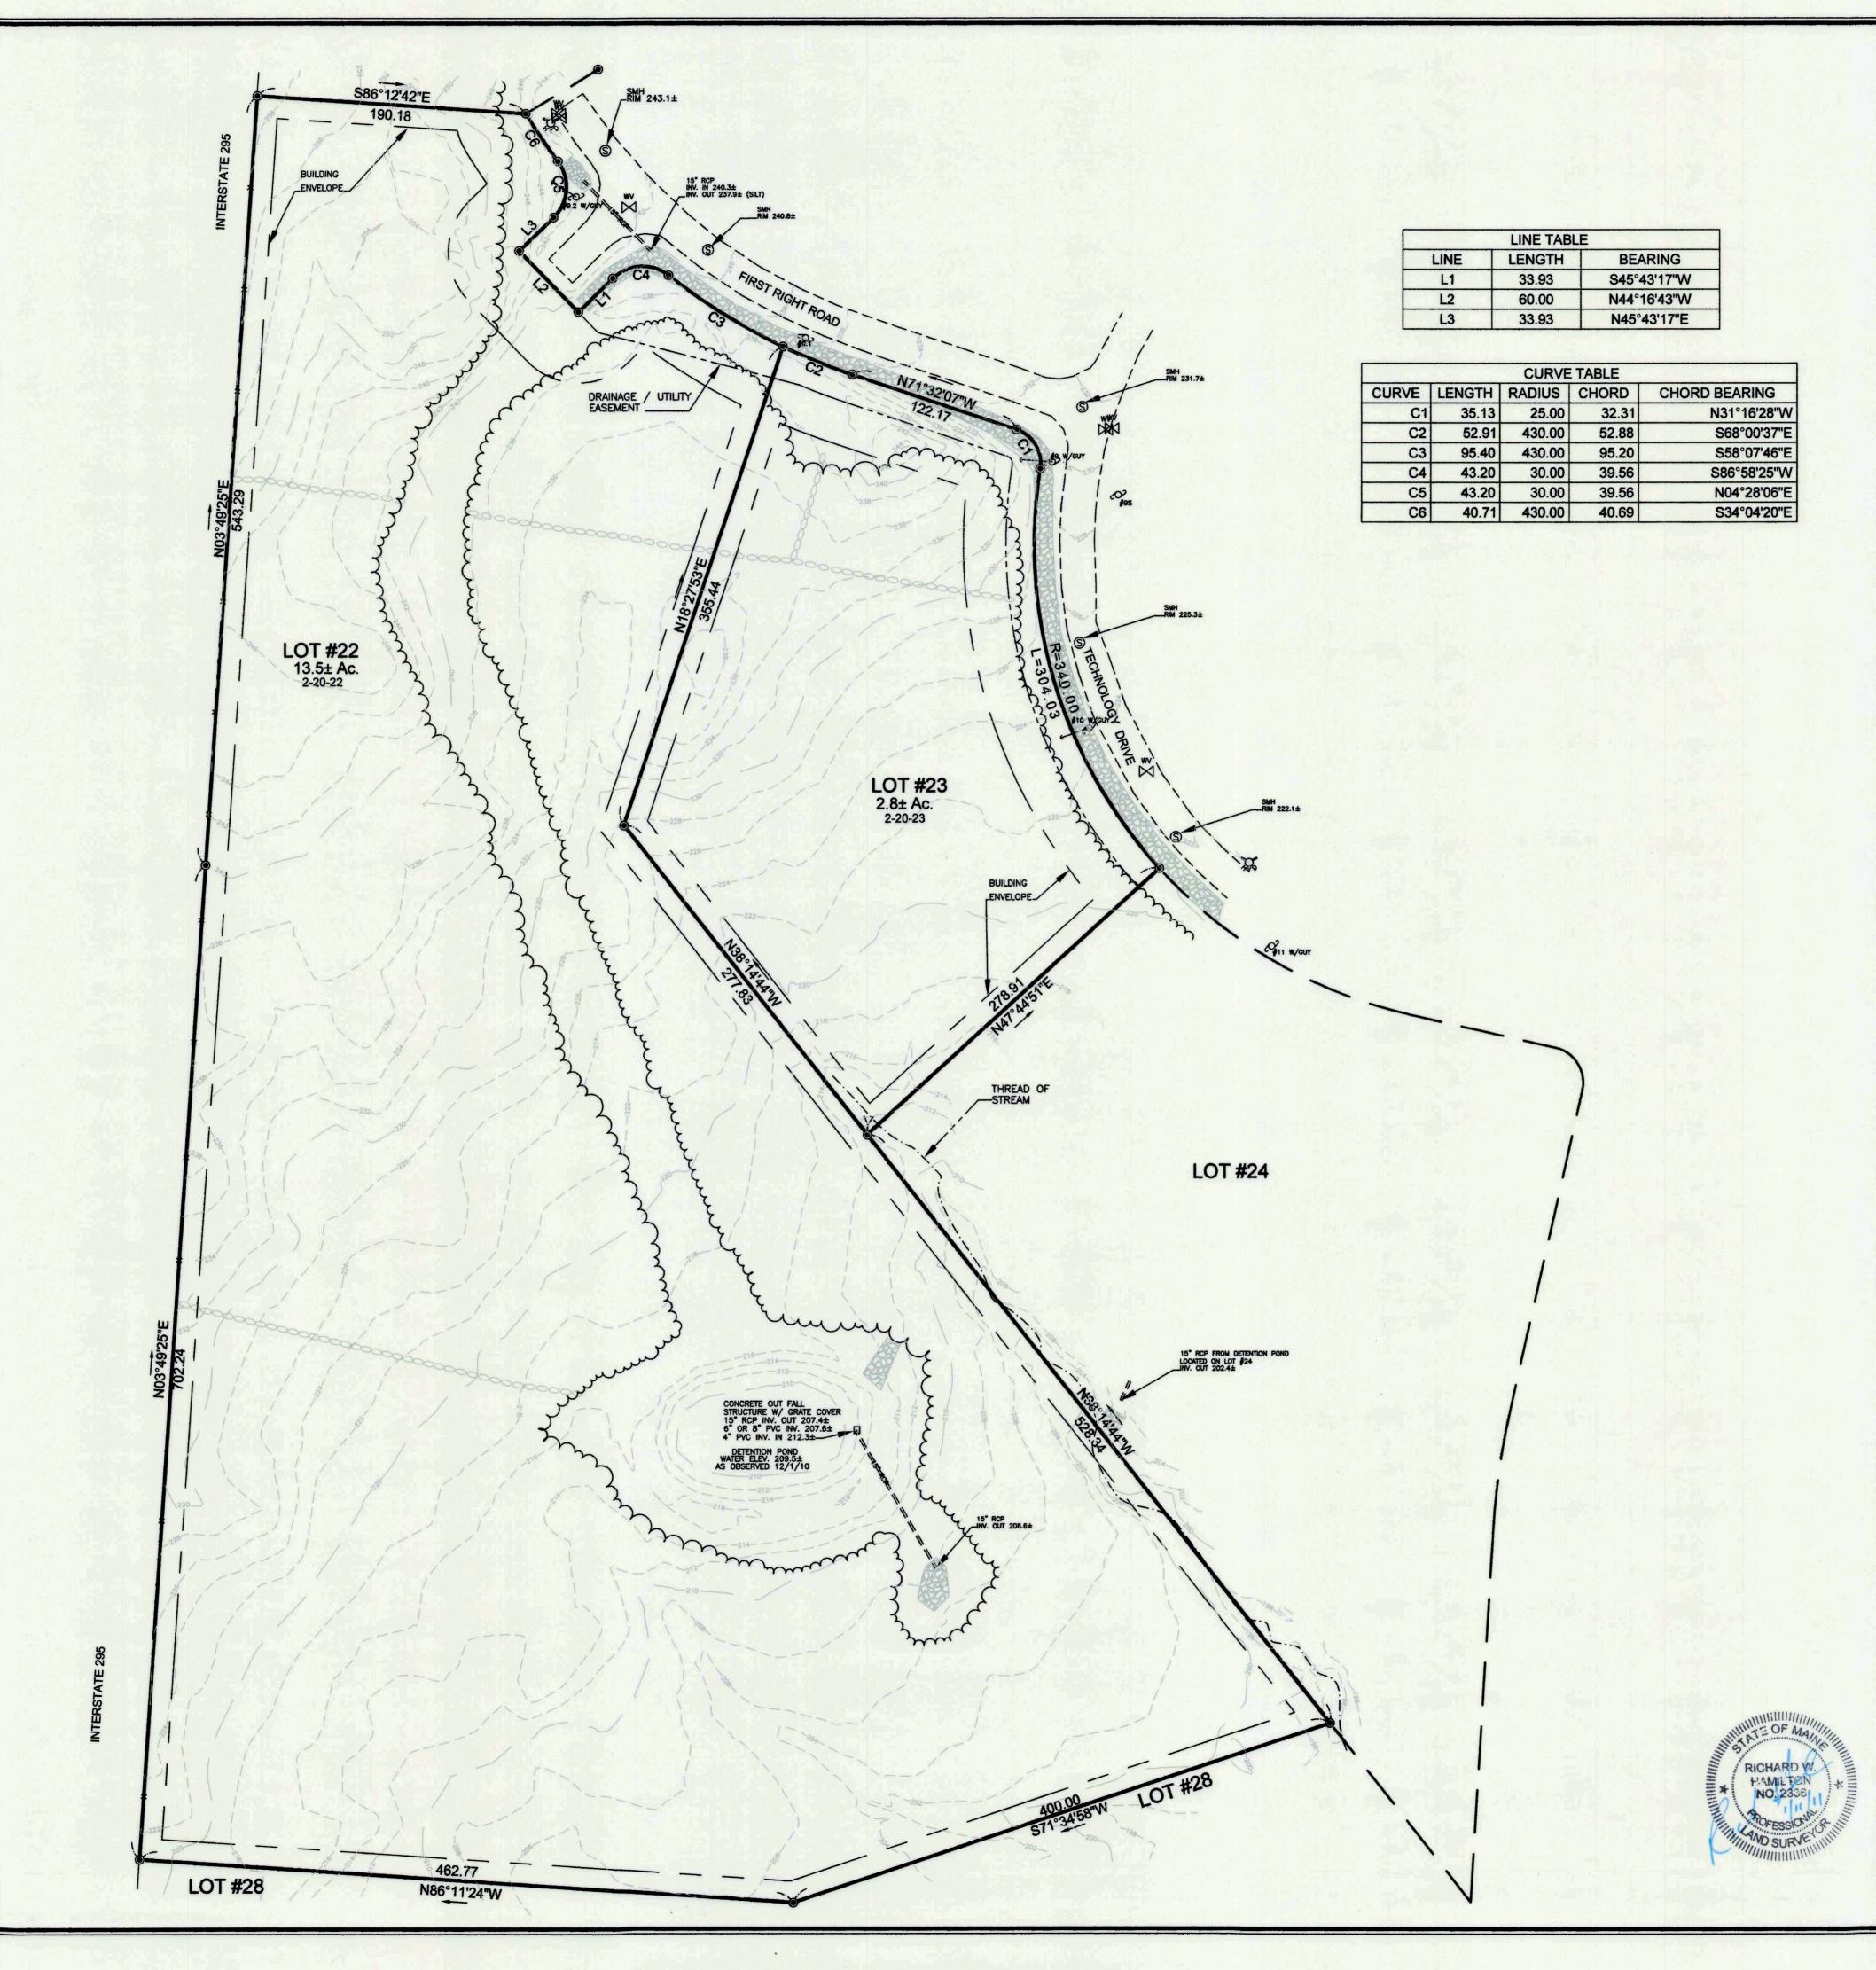

LEGEND

● FOUND REBAR W/ ALUMINUM CAP STAMPED MAINE

COAST SURVEYING PLS #1191

© UTILITY POLE (NUMBERED AS INDICATED)

SEWER MANHOLE

WATER VALVE
HYDRANT

BOUNDARY LINE
EDGE OF PAVEMENT

TREE LINE

RIP-RAP
45-6-78 TAX MAP-BLOCK-LOT

STONE WALL

NOTES

HORIZONTAL- BASED UPON PLAN REFERENCED IN NOTE #2. MAINE STATE PLANE WEST (NAD83)

VERTICAL- BASED UPON TBM A FROM RECORD DRAWING- MANHOLE #69 RIM ELEVATION 264.80.

2. PROPERTY LINES AS SHOWN ARE BASED UPON PLAN ENTITLED "LIBBY HILL BUSINESS PARK PHASE 2. WEEKS ROAD AND ENTERPRISE AVENUE, GARDINER MAINE. PREPARED BY MAINE COAST SURVEYING. RECORDED IN PLAN BOOK 2007, PAGE 137 & 138 AT THE KENNEBEC COUNTY REGISTRY OF DEEDS.

2. OWNERSHIP OF THE PROPERTY SHOWN AS INDICATED BY THE CITY OF GARDINER TAX ASSESSOR'S OFFICE IS THE CITY OF GARDINER AS RECORDED IN DEED BOOK 9125, PAGE 310 KCRD.

3. THE PROPERTY SHOWN IS IDENTIFIED ON THE CITY OF GARDINER TAX ASSESSOR'S MAP 2 PARCELS 20-22 & 20-23.

4. THE PROPERTY SHOWN IS LOCATED WITHIN THE PLANNED INDUSTRIAL / COMMERCIAL ZONE AS DEFINED BY THE CITY OF GARDINER'S ZONING ORDINANCE.

5. BULK AND SPACE REQUIREMENTS FOR THE PLANNED INDUSTRIAL / COMMERCIAL ZONE ARE AS FOLLOWS:

MINIMUM LOT SIZE W/ SEWER 40,000 SF W/O SEWER 80,000

MINIMUM ROAD FRONTAGE 200' MAXIMUM HEIGHT 150'

SETBACKS: FRONT 50'

SIDE 15' REAR 15'

6. WETLANDS WERE OBSERVED DURING THE COURSE OF PERFORMING THE FIELD SURVEY PER REQUEST OF THE CLIENT WERE NOT LOCATED.

EXISTING CONDITIONS LOTS 22 & 23

LIBBY HILL BUSINESS PARK

KENNEBEC COUNTY
MAINE

SCALE: 1"=100"

JANUARY 11, 2011

PREPARED FOR: ST. GERMAIN COLLINS 846 MAIN ST, SUITE 3 WESTBROOK, MAINE 04092

BOUNDARY ENGINEERING SURVEY TECHNOLOGY


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DRAWING I

DRAWING FILE: 001-040


60' 120' 24



- THE PURPOSE OF THIS PLAN IS TO DEPICT THE EXISTING CONDITIONS FOR FOR TAX MAP 2 LOT 20-22 IN GARDINER, MAINE. THE TOTAL AREA OF THE SUBJECT PARCEL IS 13.49± ACRES.
- 2. THE OWNER OF RECORD IS GARDINER TRANSFER COMPANY, LLC, C/O TROIANO WASTE SERVICES, INC, PO BOX 3541, PORTLAND, MAINE 04104 RECORDED IN THE KENNEBEC COUNTY REGISTRY OF DEEDS BOOK 12224
- PROPERTY BOUNDARIES ARE BASED ON A PLAN ENTITLED "LIBBY HILL BUSINESS PARK PHASE 2, WEEKS ROAD AND ENTERPRISE AVENUE, GARDINER, MAINE" PREPARED BY MAINE COAST SURVEYING AND RECORDED IN THE KENNEBEC COUNTY REGISTRY OF DEEDS PLAN BOOK 2007, PAGE
- 4. TOPOGRAPHIC INFORMATION IS BASED ON A PLAN ENTITLED "EXISTING CONDITIONS LOTS 22 & 23 LIBBY HILL BUSINESS PARK" BY BOUNDARY ENGINEERING SURVEY TECHNOLOGY, DATED AUGUST 7, 2015. TOPOGRAPHIC ELEVATIONS ARE BASED ON TEMPORARY BENCHMARK A FROM RECORD DRAWING - MANHOLE NO. 69 RIM ELEVATION 264.80. HORIZONTAL DATA BASED ON NAD83 MAINE STATE PLANE WEST DATUM.
- 5. WETLAND BOUNDARIES OBTAINED FROM A FIELD SURVEY PERFORMED BY MICHAEL JOHNSON OF WOODLOT ALTERNATIVES, INC ON AUGUST 6, 2004 AND FIELD VERIFIED BY TOM TETREAU, PWS OF STANTEC CONSULTING SERVICES, INC ON DECEMBER 20, 2019. 6. THE EXISTENCE AND/OR LOCATION OF UTILITIES SHOWN ON THIS PLAN IS
- APPROXIMATE. ALL UNDERGROUND UTILITIES SHALL BE VERIFIED AS TO THEIR LOCATION, SIZE, AND TYPE BY THE PROPER UTILITY COMPANIES PRIOR TO CONSTRUCTION.
- 7. CONTRACTOR TO CONTACT DIG SAFE A MINIMUM 72 HOURS, EXCLUDING WEEKENDS AND HOLIDAYS, PRIOR TO CONSTRUCTION.

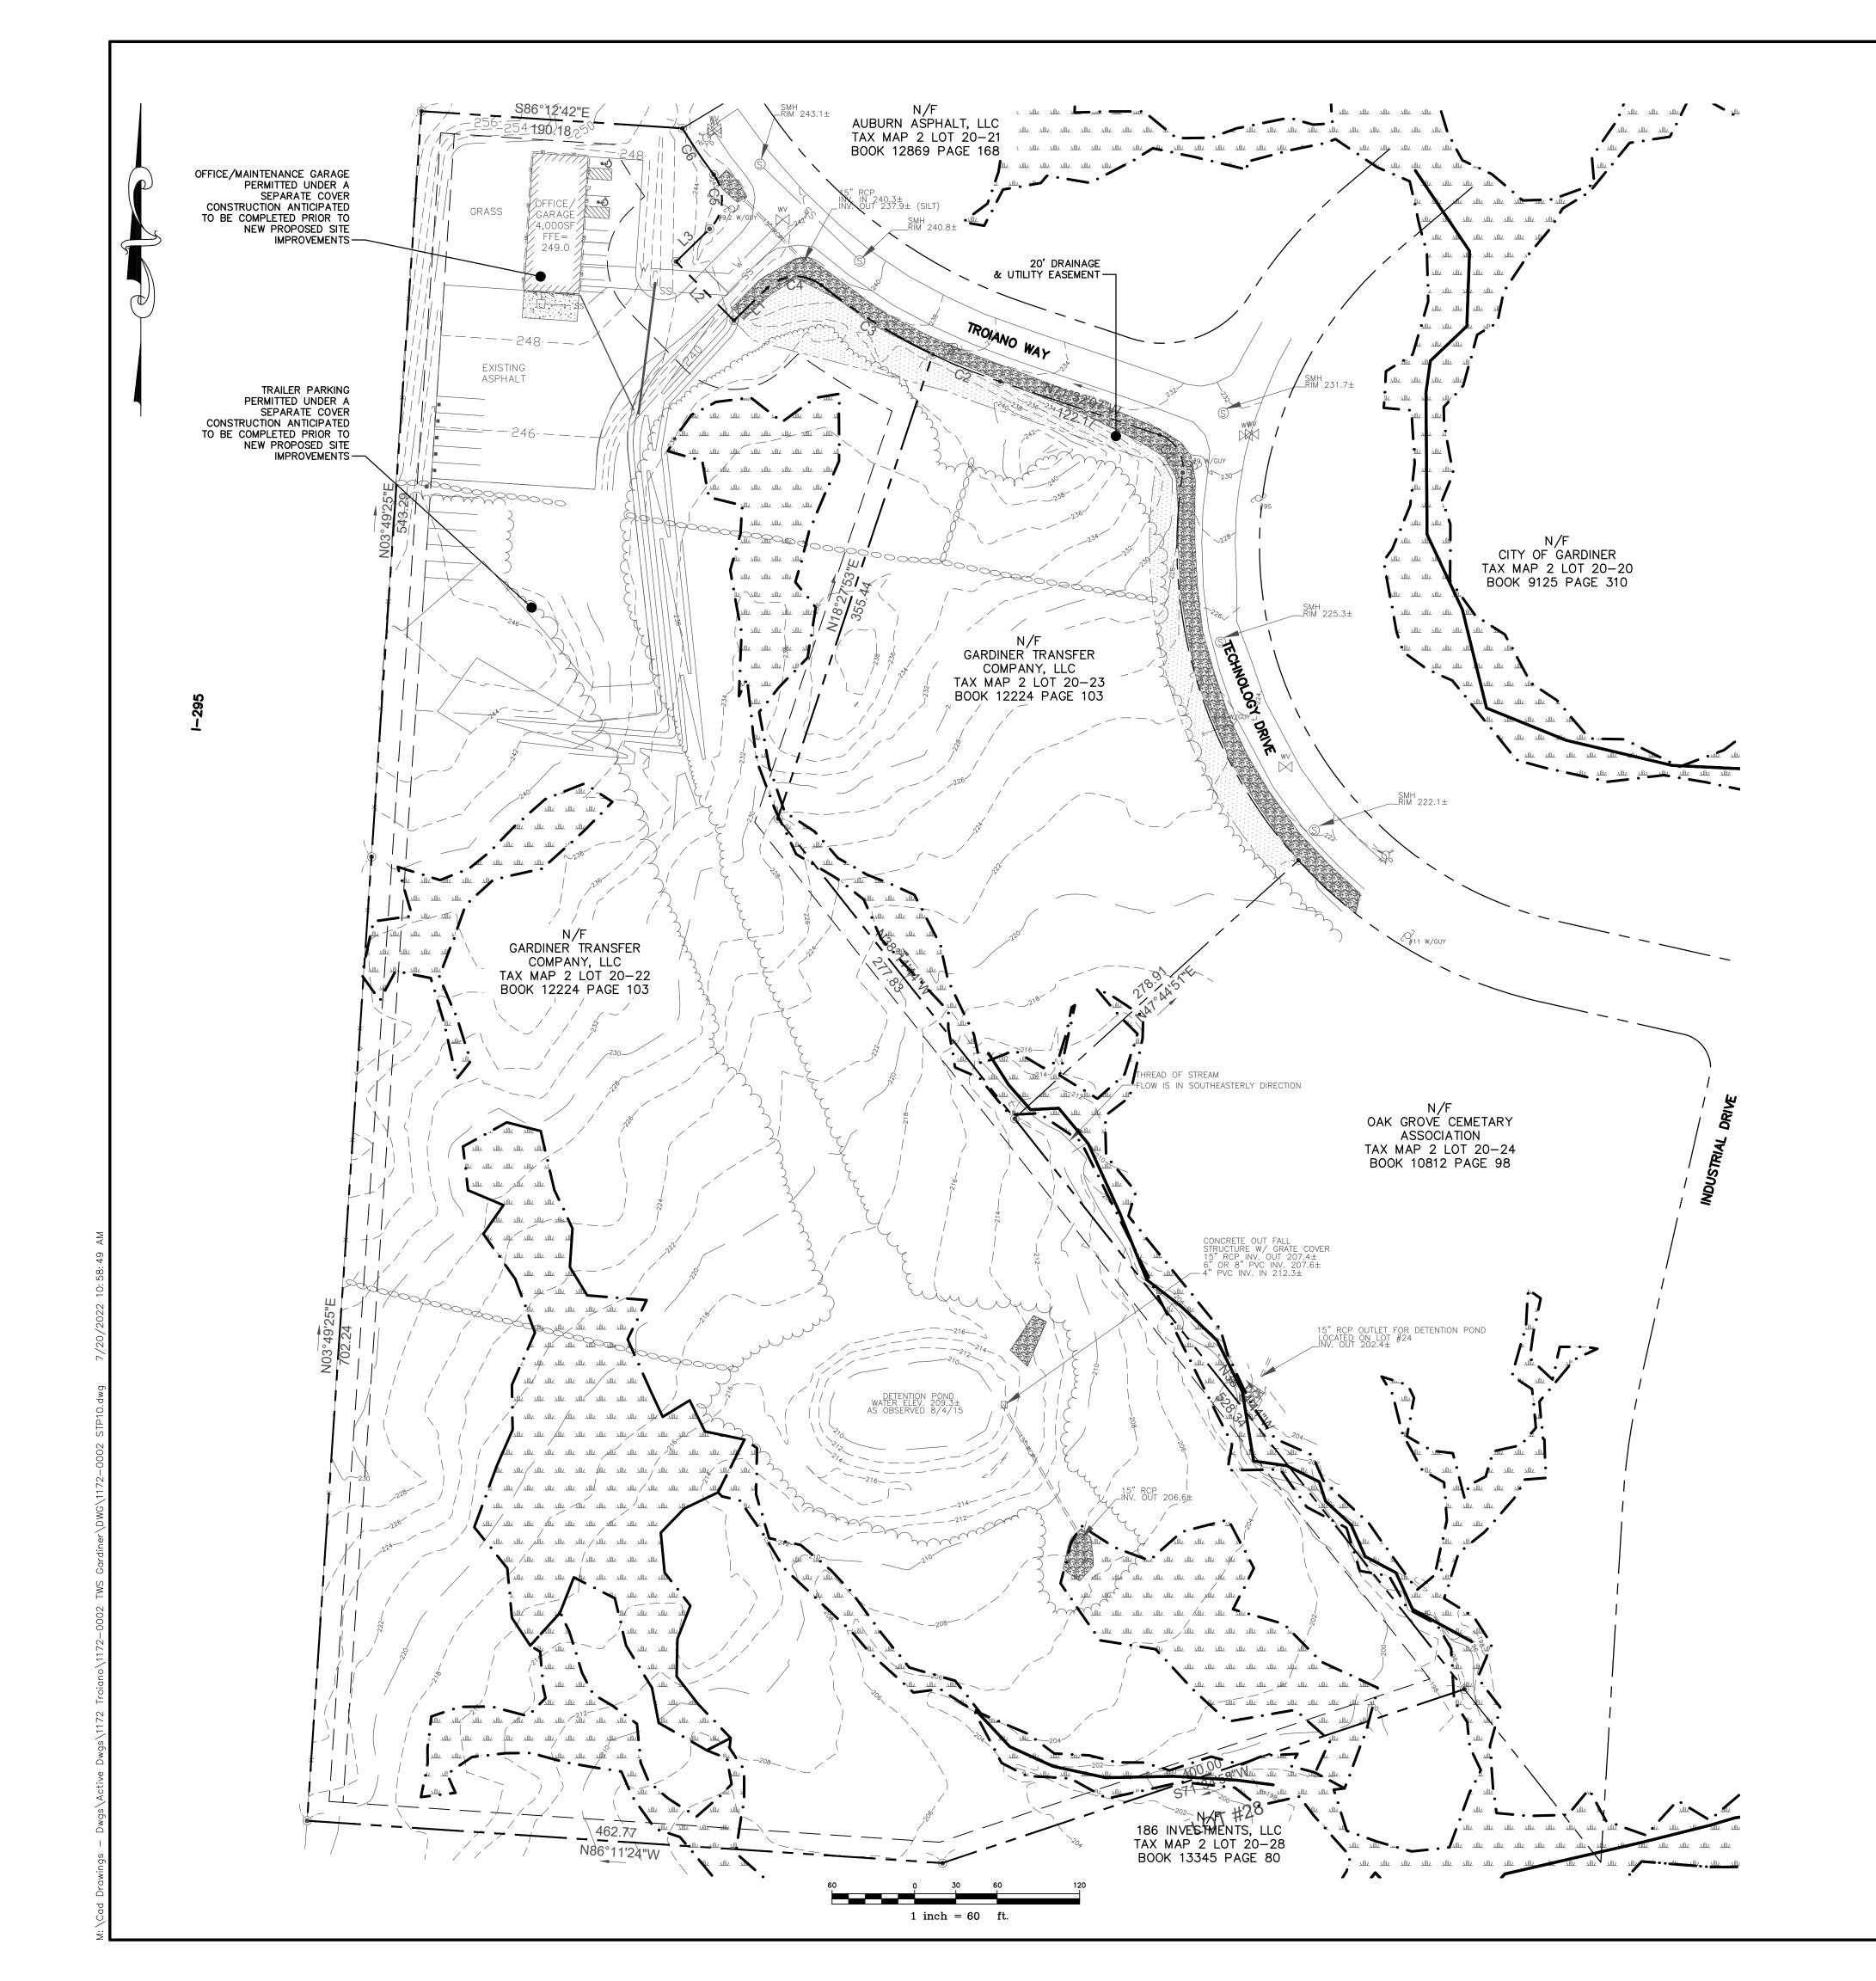

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REV.	DATE	REVISION DESCRIPTION

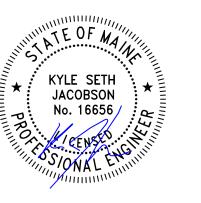DESIGNED BY: DRAWN BY: CHECKED BY: PJC DATE: FILE NAME: 1172-0002 STP10.dwg

PROJECT NAME:

LOT 22 LIBBY HILL BUSINESS PARK 12 TROIANO WAY GARDINER, MAINE

CLIENT:

GARDINER TRANSFER COMPANY, LLC PO BOX 3541 PORTLAND, MAINE

SHEET TITLE:

EXISTING CONDITIONS PLAN

SHEET NO:

C-101

<u>LEGEND</u>

SETBACKS MONUMENTS

BUILDINGS


STONEWALL


SIGNS BOLLARDS

UTILITY POLE

EXISTING RIPRAP

PROPERTY LINE/ROW ADJACENT PROPERTY LINE EXISTING/PROPOSED CONTOURS EDGE OF GRAVEL EDGE OF PAVEMENT EDGE OF WETLAND WETLAND SYMBOL PAVEMENT STRIPING EXISTING/PROPOSED TREELINE · ~~·~·~· . NRCS WEB SOIL SURVEY BOUNDARY

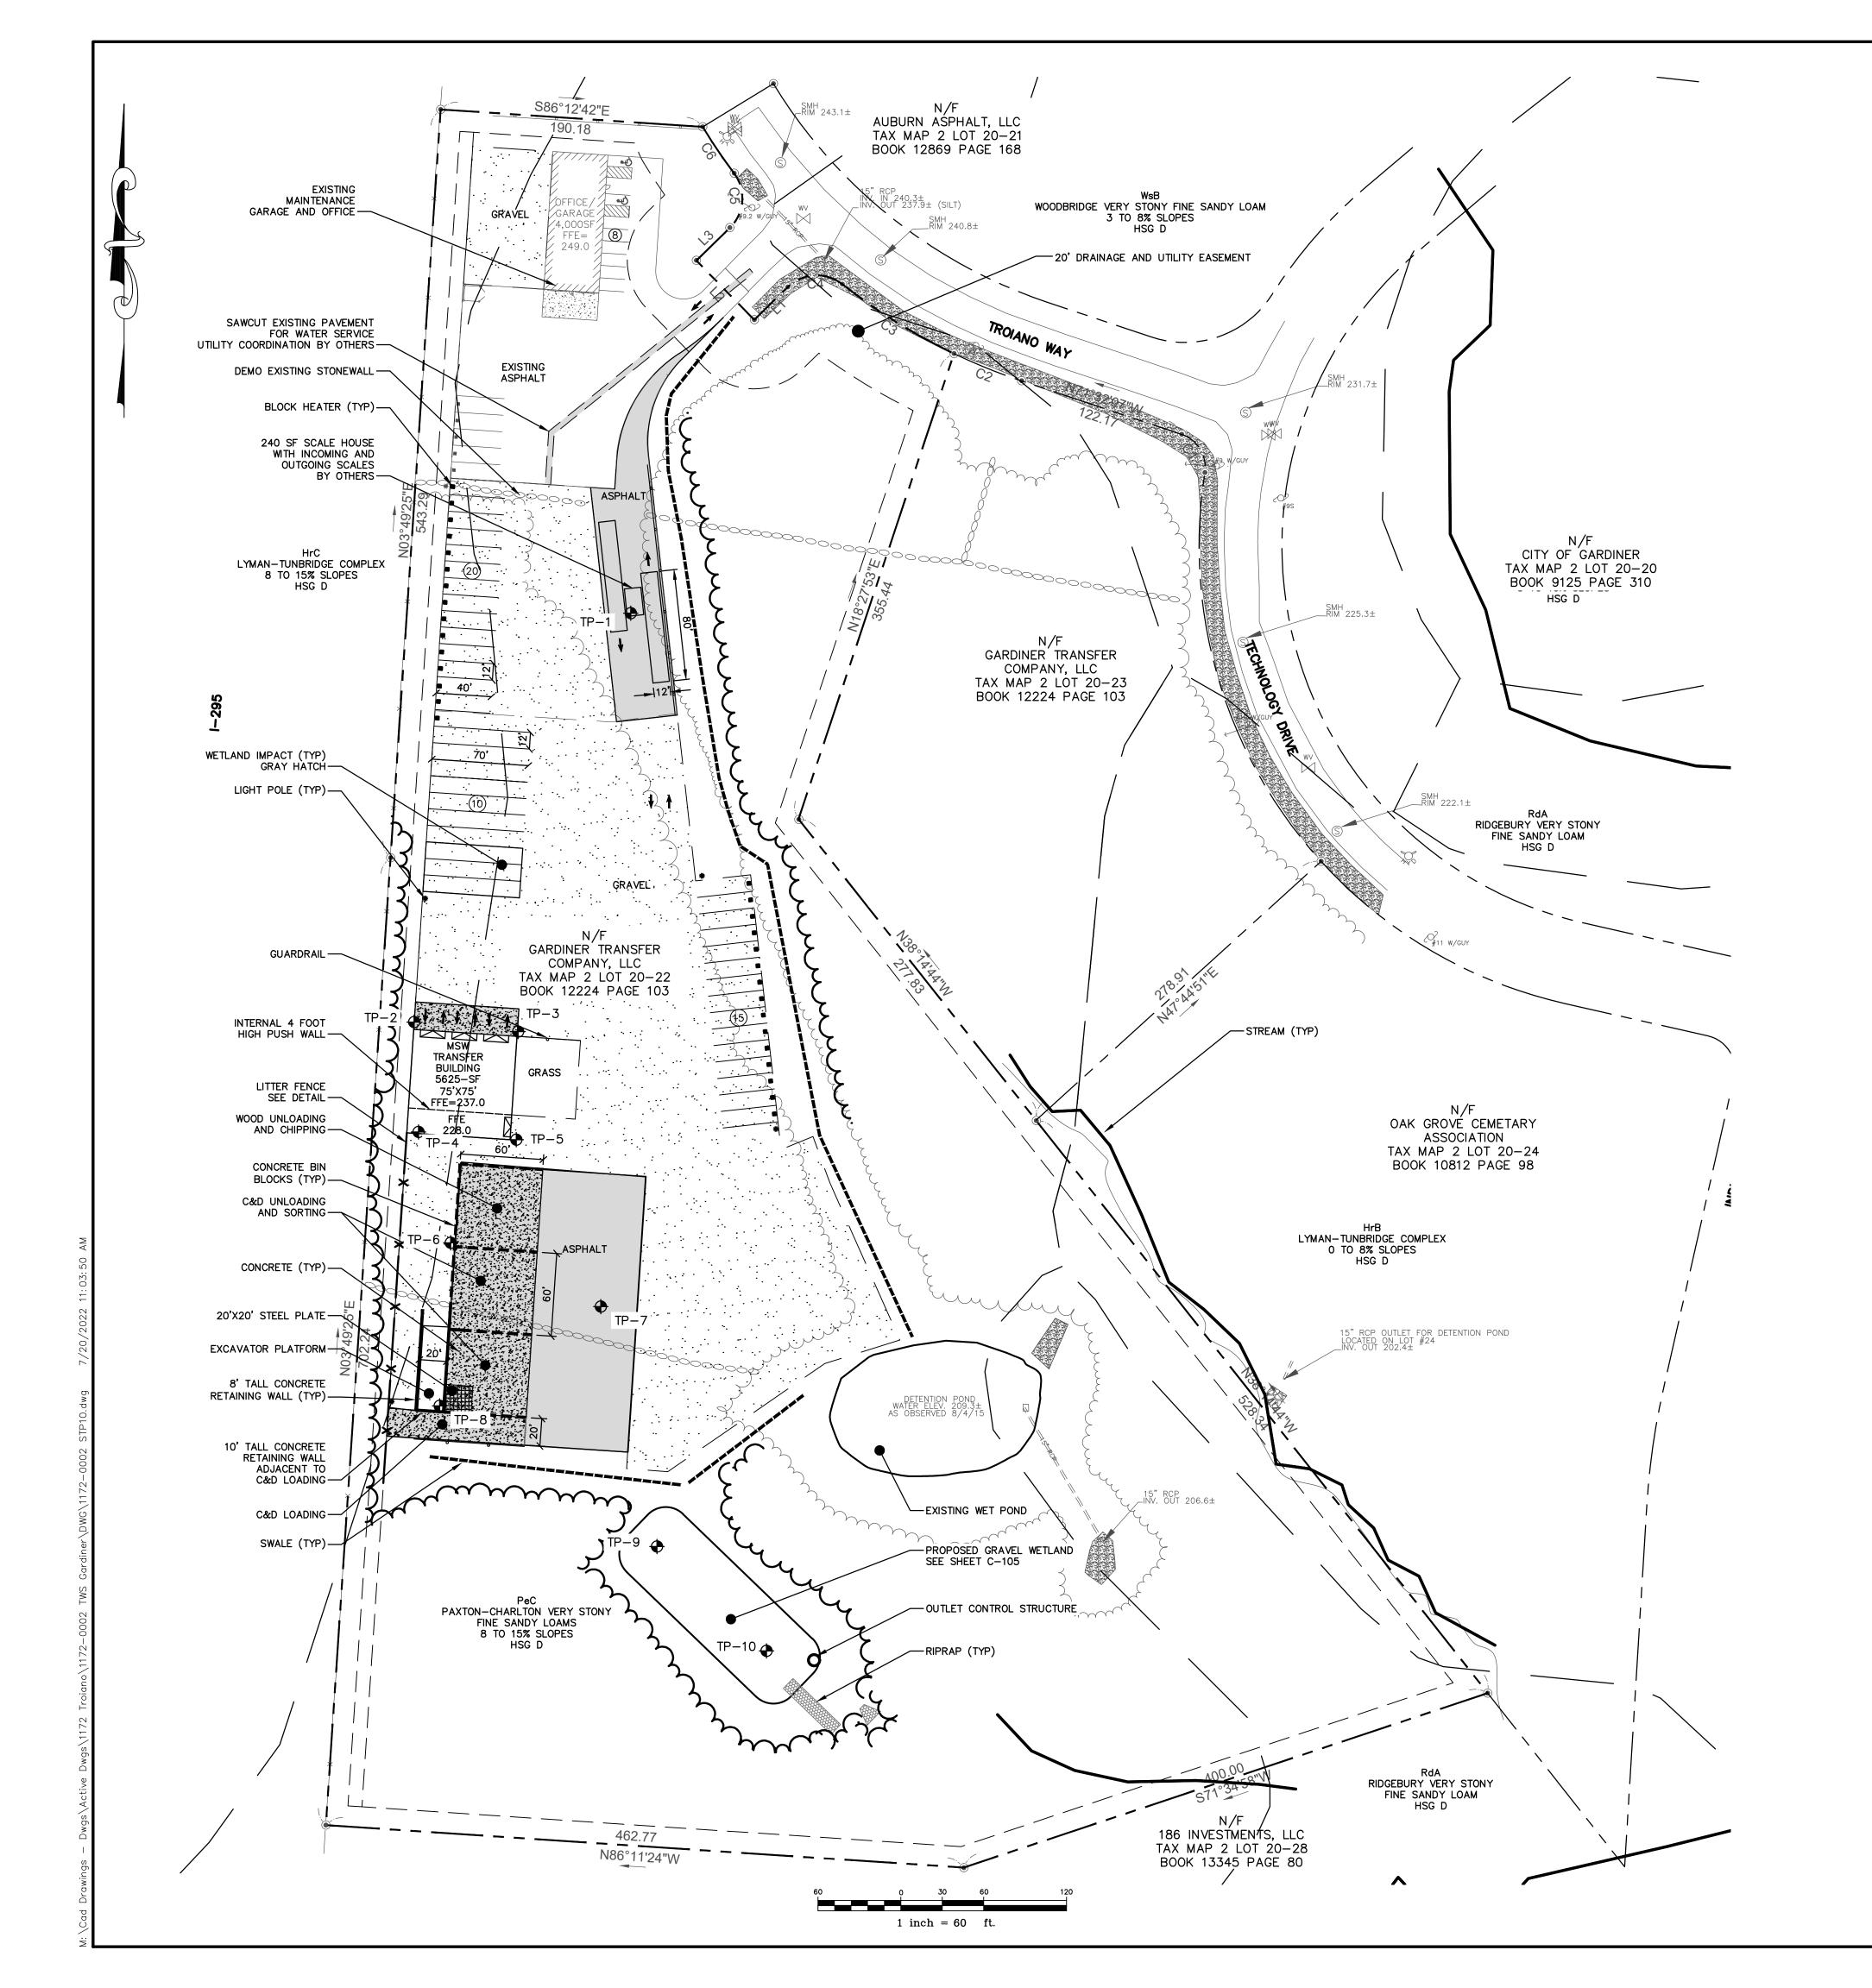

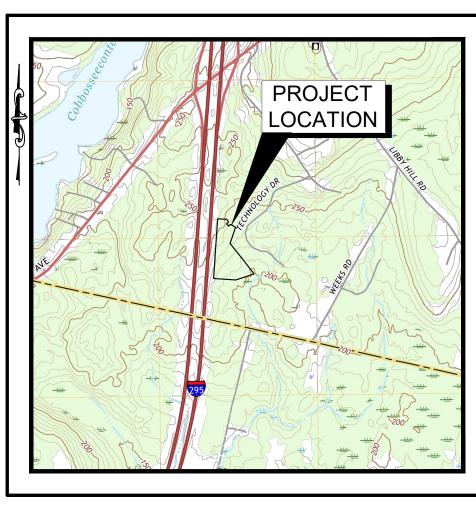

SITE LOCATION MAP

SCALE: 1" = 2,000'± SOURCE: USGS, GARDINER, MAINE, QUADRANGLE, DATED 2018

NOTE

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- 6. THE PROPERTY IS LOCATED WITHIN THE CITY OF GARDINER PLANNED INDUSTRIAL /COMMERCIAL (PIC) DISTRICT ZONE.
- 7. WASTE PROCESSING FACILITY USE AND AUTOMOBILE REPAIR USE ARE ALLOWED USES VIA PERMIT WITH REVIEW IN THE PIC DISTRICT ZONE.
- 8. BULK AND DIMENSIONAL REQUIREMENTS FOR THE PIC DISTRICT ZONE ARE

AS FOLLOWS:		
	REQUIRED	PROPOSED
MIN. LOT SIZE WITH SEWER	40,000 SF	NA
MIN. LOT SIZE W/O SEWER	80,000 SF	588,060 SF
MIN. ROAD FRONTAGE	200 FT	248 FT
MIN. SHORE FRONTAGE	125 FT	NA
MAX BLDG HEIGHT	150 FT	50 FT
MAX. LOT COVERAGE	80%	46%
ROAD (FRONT) SETBACK*	50/75 FT	50 FT
SIDE SÈTBACK	15 [°] FT	15 FT

*SETBACKS FROM STREETS OR ROADS SHALL BE THE GREATER OF TWO DISTANCES X/Y WHERE X IS MEASURED FROM THE RIGHT-OF-WAY LINE AND Y IS MEASURED FROM THE CENTER LINE.

15 FT

9. PARKING REQUIREMENTS FOR THE INDUSTRIAL AND MANUFACTURING FACILITIES ARE 1.5 SPACES PER 1,000 SF GROSS FLOOR AREA (GFA). THE PROPOSED DEVELOPMENT (9,625 SF COMBINED GFA) REQUIRES 15 PARKING SPACES, THE FOLLOWING PARKING SPACES ARE PROPOSED:

PARKING PROPOSED 13 STANDARD SPACES (9' X 18')

REAR SETBACK

2 ADA ACCESSIBLE SPACES

15 TOTAL PROPOSED STANDARD SPACES

35 TRUCK PARKING SPACES (12' X 40')

- 10 TRACTOR TRAILER SPACES (12' X 70')
- 10. THE EXISTENCE AND/OR LOCATION OF UTILITIES SHOWN ON THIS PLAN IS APPROXIMATE. ALL UNDERGROUND UTILITIES SHALL BE VERIFIED AS TO THEIR LOCATION, SIZE, AND TYPE BY THE PROPER UTILITY COMPANIES PRIOR TO CONSTRUCTION.
- 11. CONTRACTOR TO CONTACT DIG SAFE A MINIMUM 72 HOURS, EXCLUDING WEEKENDS AND HOLIDAYS, PRIOR TO CONSTRUCTION.
- 12. THE PROJECT PROPOSES 38,127 SF OF WETLAND IMPACTS.
- 13. THE SOLID WASTE HANDLING AREA TOTALS APPROXIMATELY 39,893 SF.

LEGEND

	PROPERTY LINE/ROW
	ADJACENT PROPERTY LINE
	SETBACKS
•0	MONUMENTS
	EDGE OF GRAVEL
	EDGE OF PAVEMENT
	EDGE OF WETLAND
<u>गाप</u>	WETLAND SYMBOL
	CURB
	PAVEMENT STRIPING
	BUILDINGS
	EXISTING/PROPOSED TREELINE
	NRCS WEB SOIL SURVEY BOUNDAR
	STONEWALL
□ -	SIGNS
•	BOLLARDS
Ø	UTILITY POLE
	EXISTING RIPRAP
4	SOIL TEST PIT



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V.	DATE	REVISION DESCRIPTION

DESIGNED BY:

DRAWN BY:

CHECKED BY:

DATE:

FILE NAME:

KSJ

PMG

PJC

7/20/2022

FILE NAME:

1172-0002 STP10.dwg

PROJECT NAME:

LOT 22 LIBBY HILL BUSINESS PARK 12 TROIANO WAY GARDINER, MAINE


CLIENT:

GARDINER TRANSFER COMPANY, LLC PO BOX 3541 PORTLAND, MAINE

SHEET TITLE:


SITE PLAN

SHEET NO:

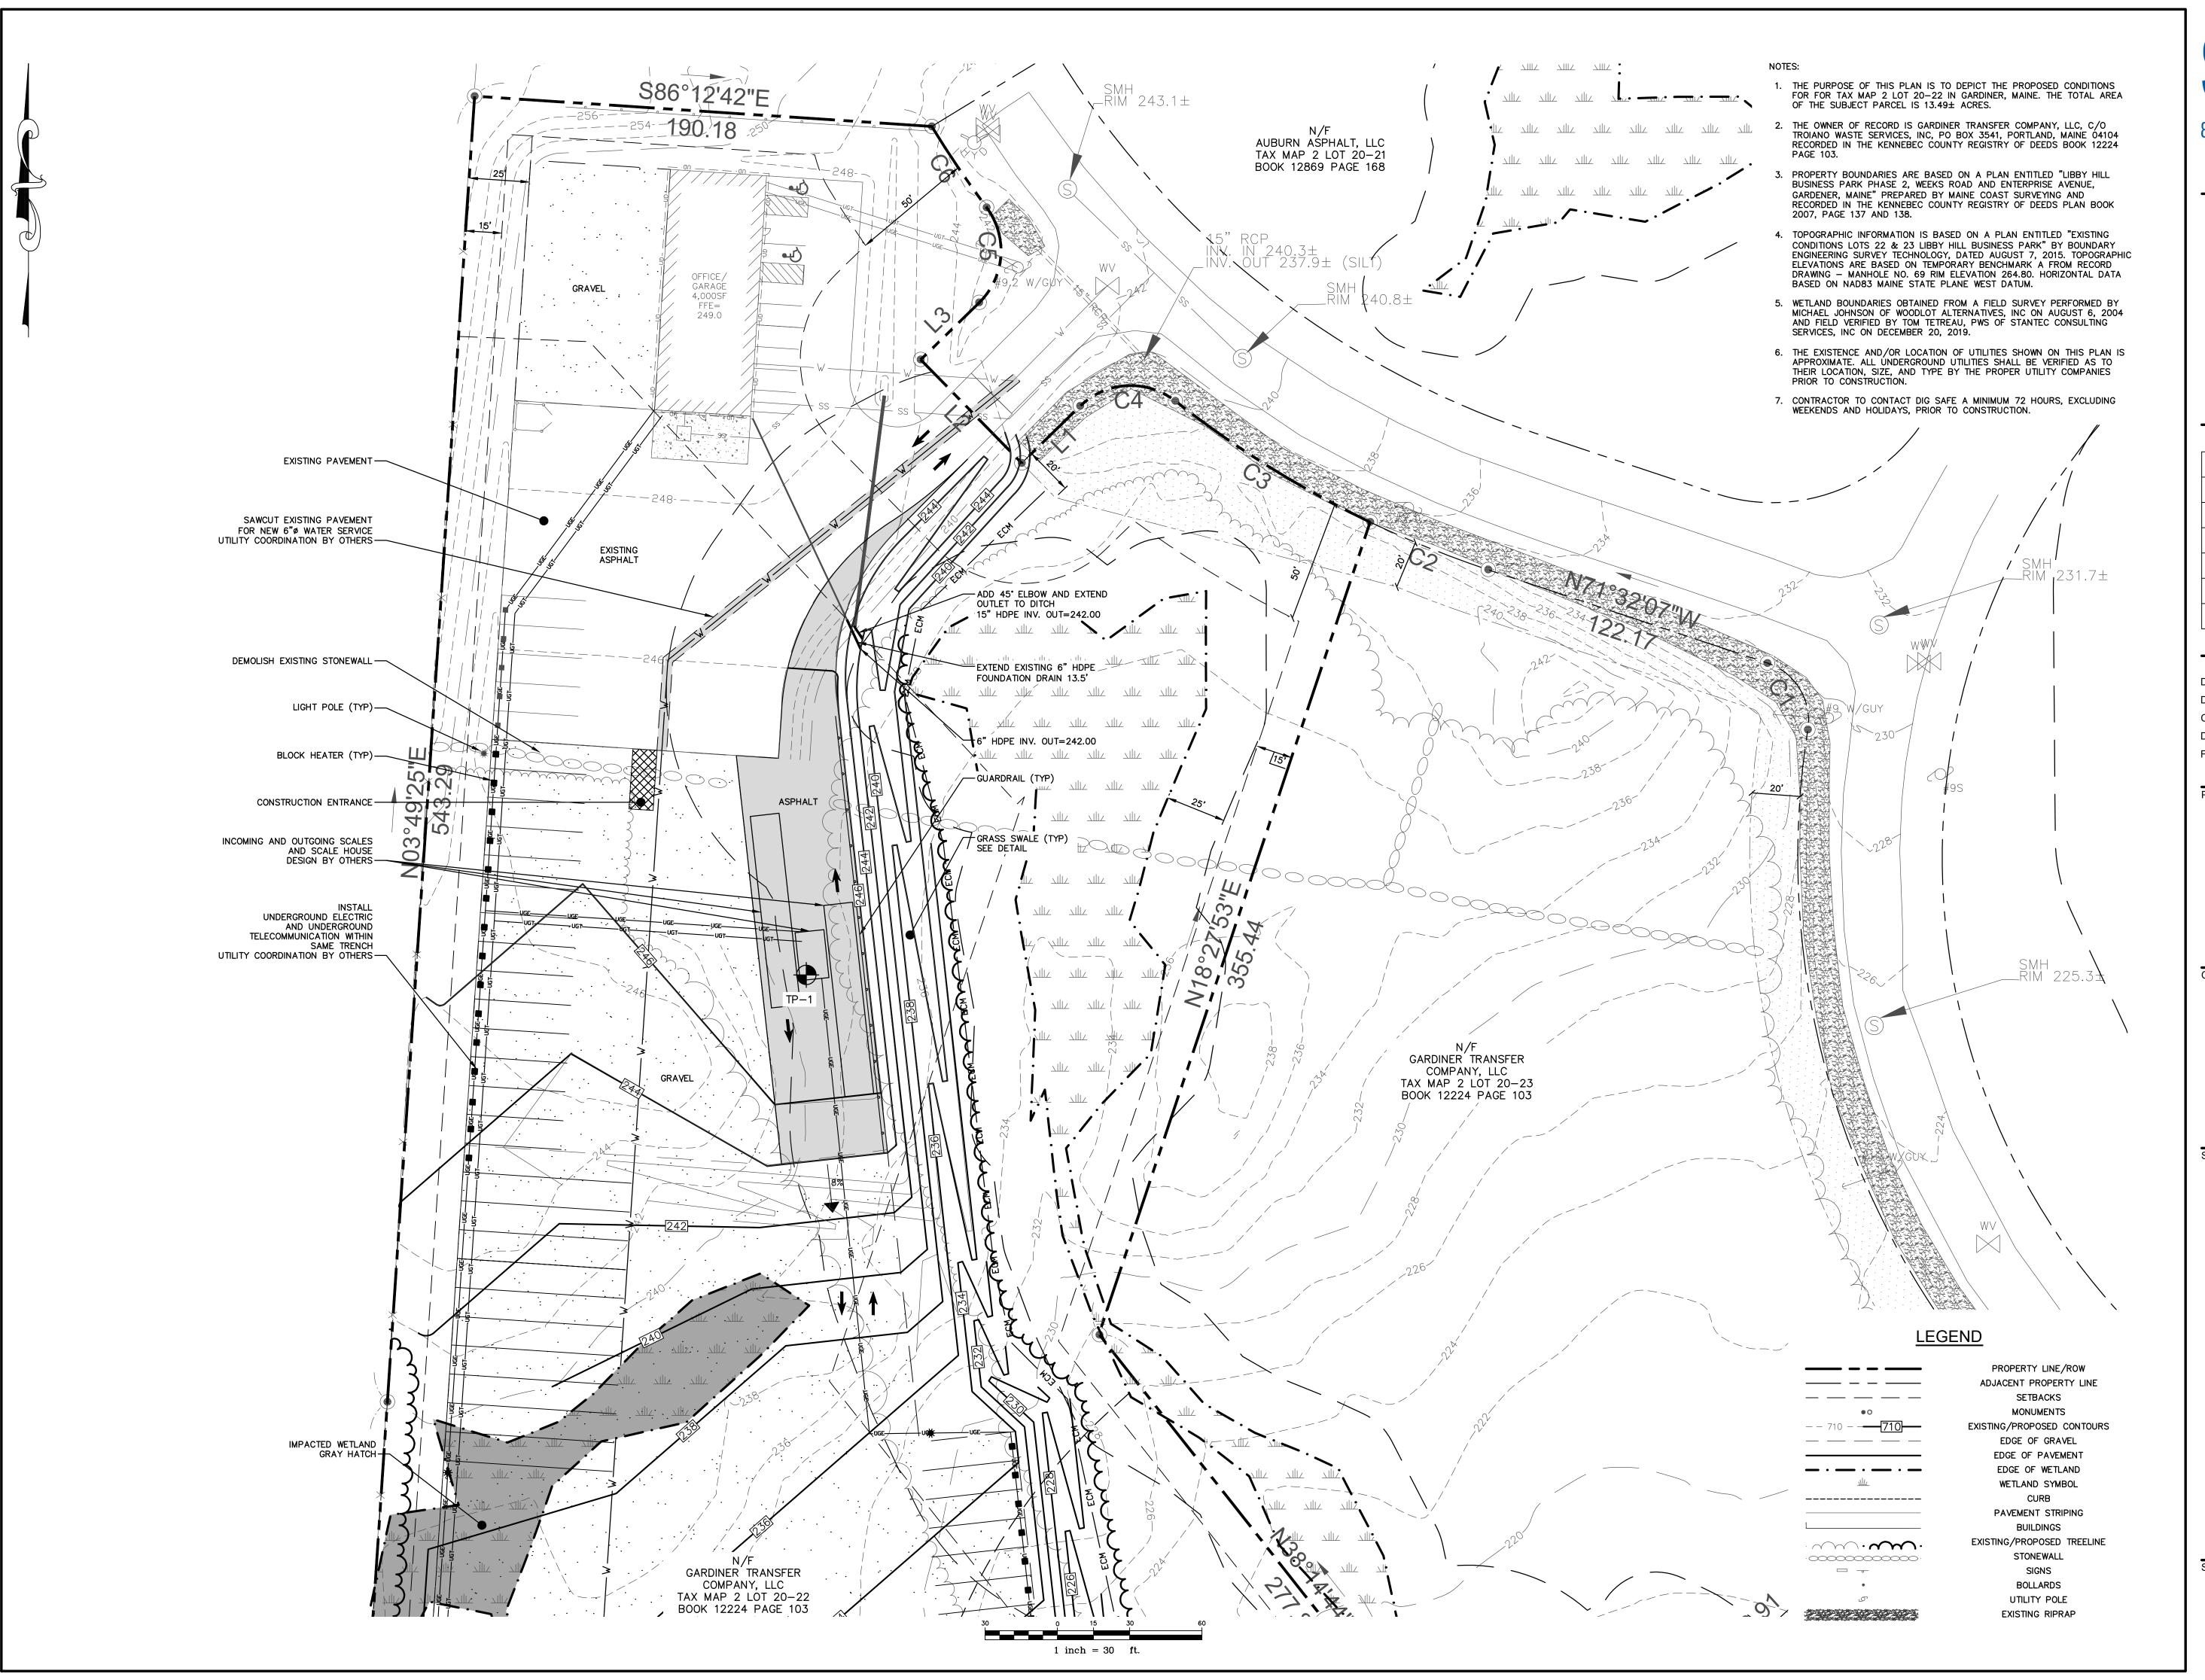



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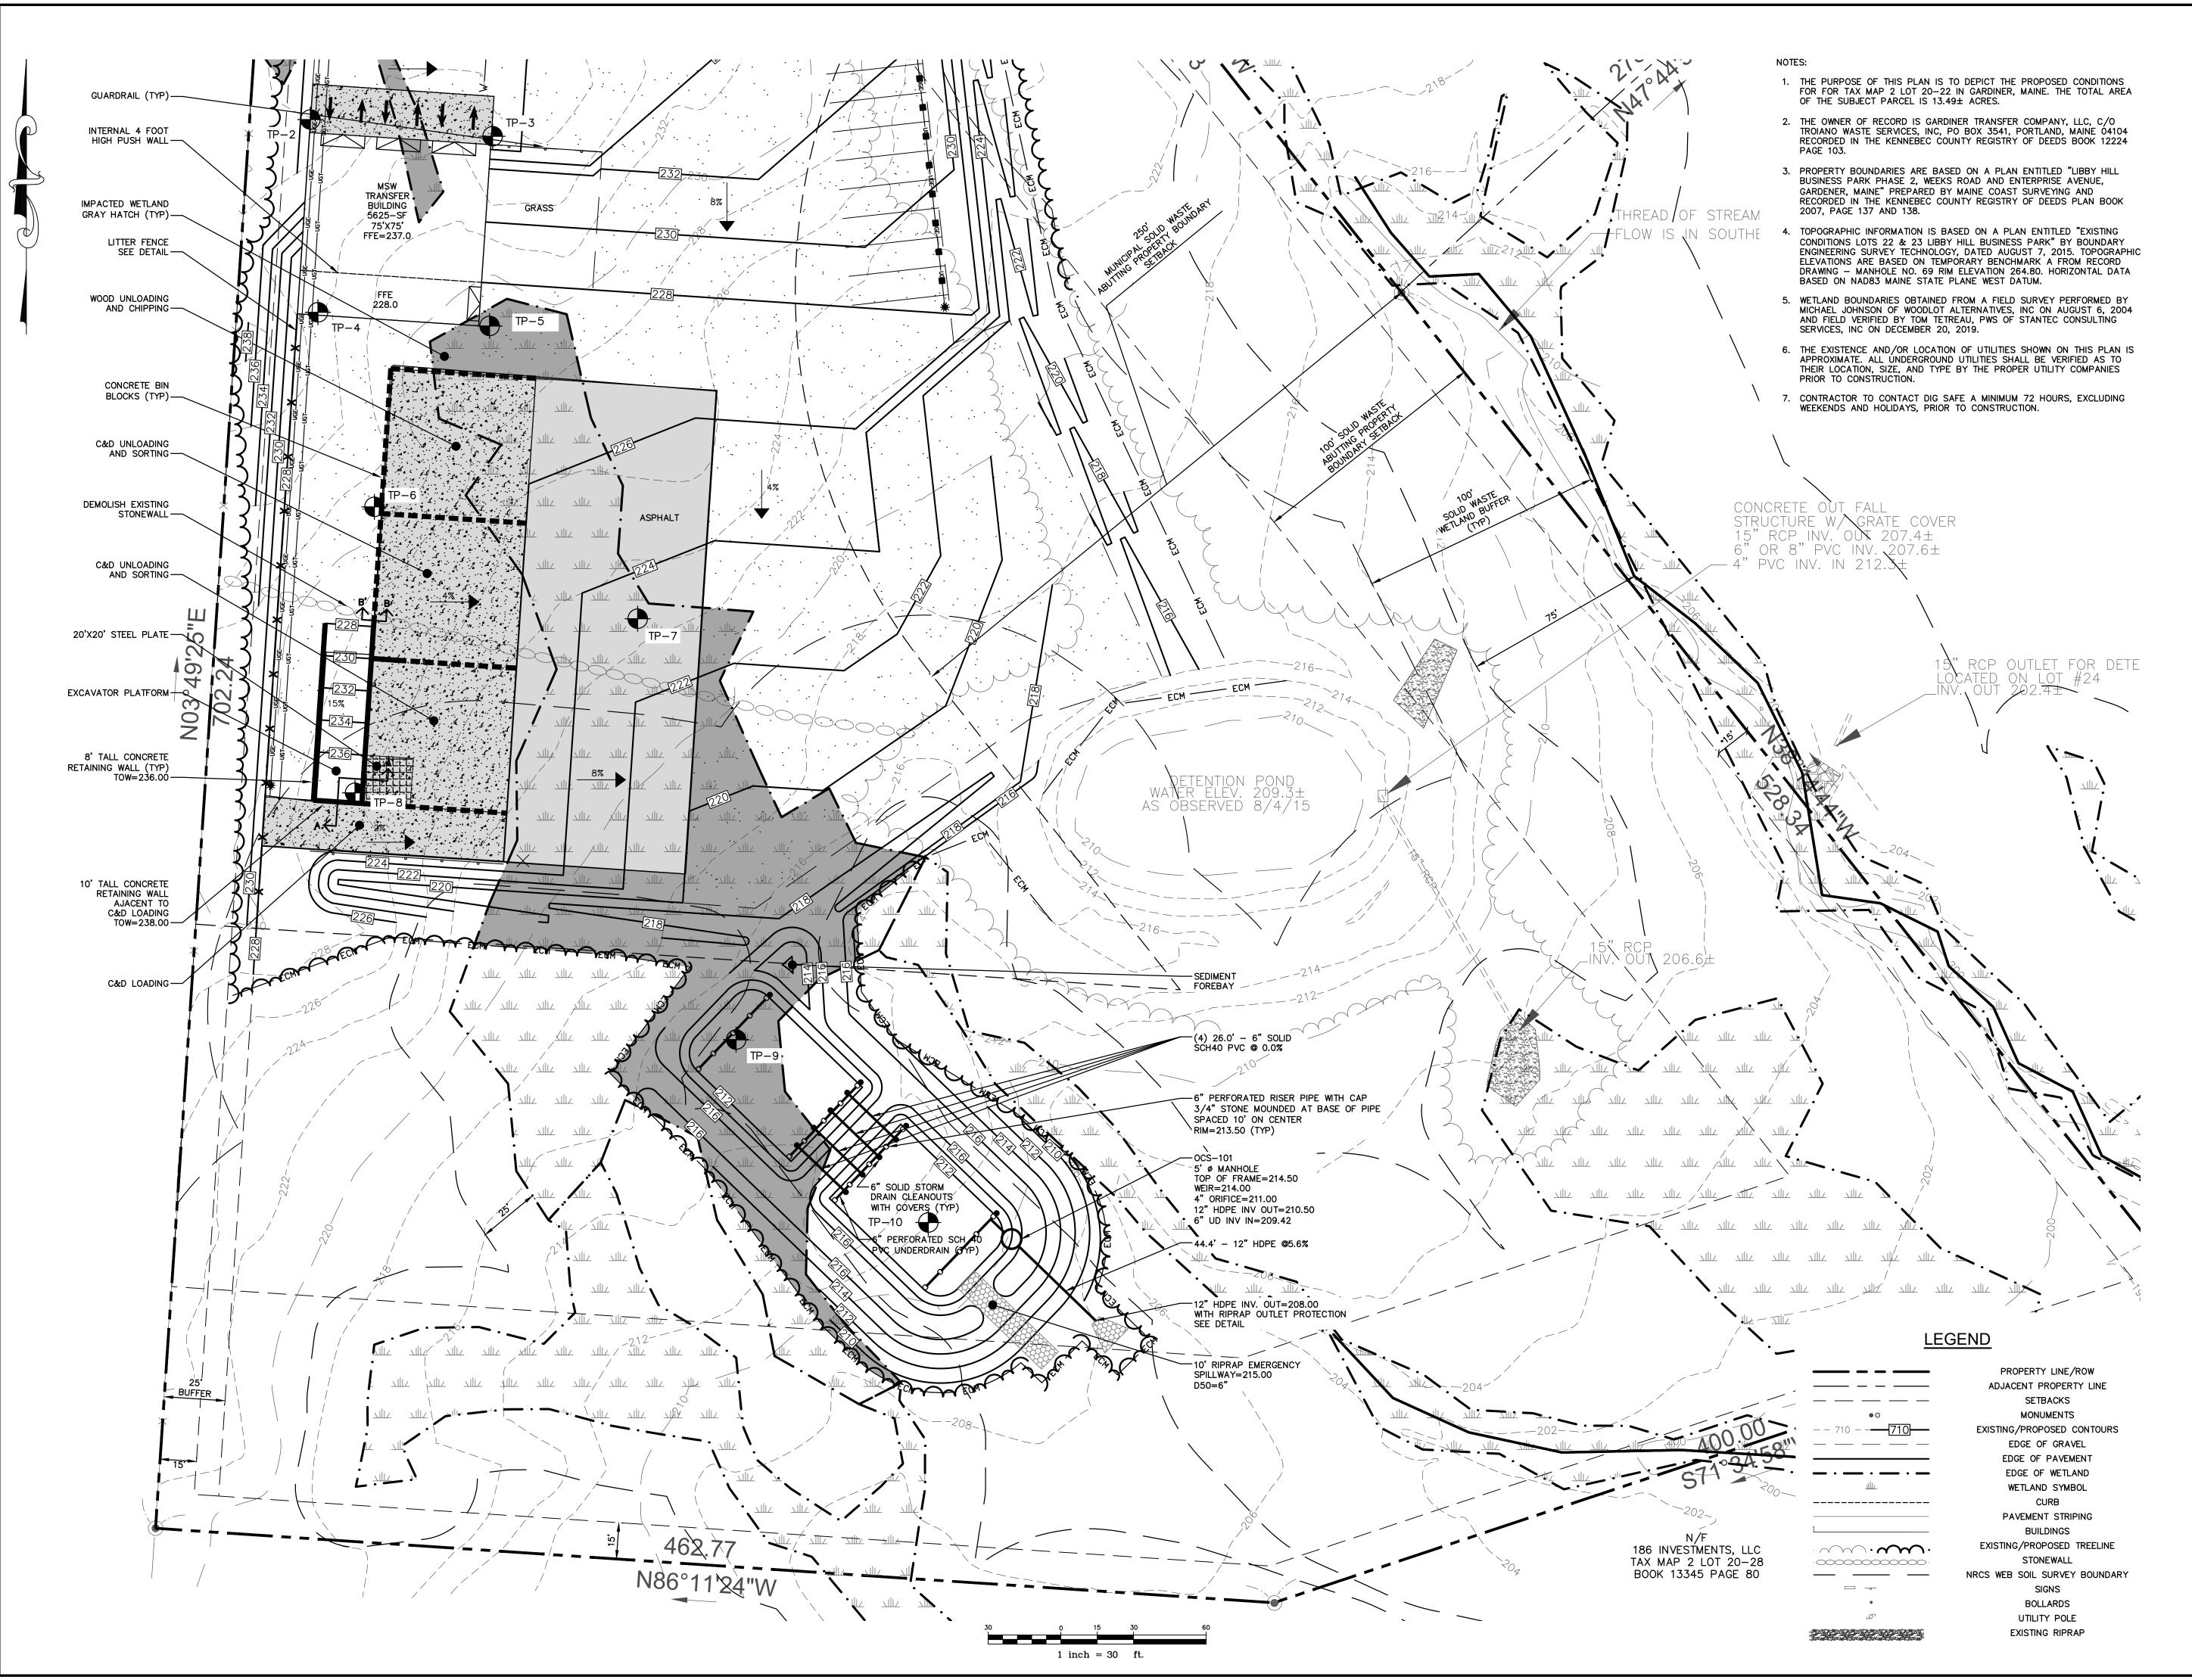
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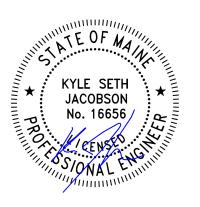
GRADING,
DRAINAGE,
UTILITIES, &
EROSION
CONTROL PLAN

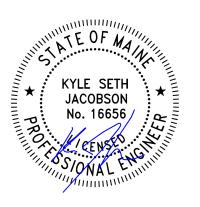SHEET NO:





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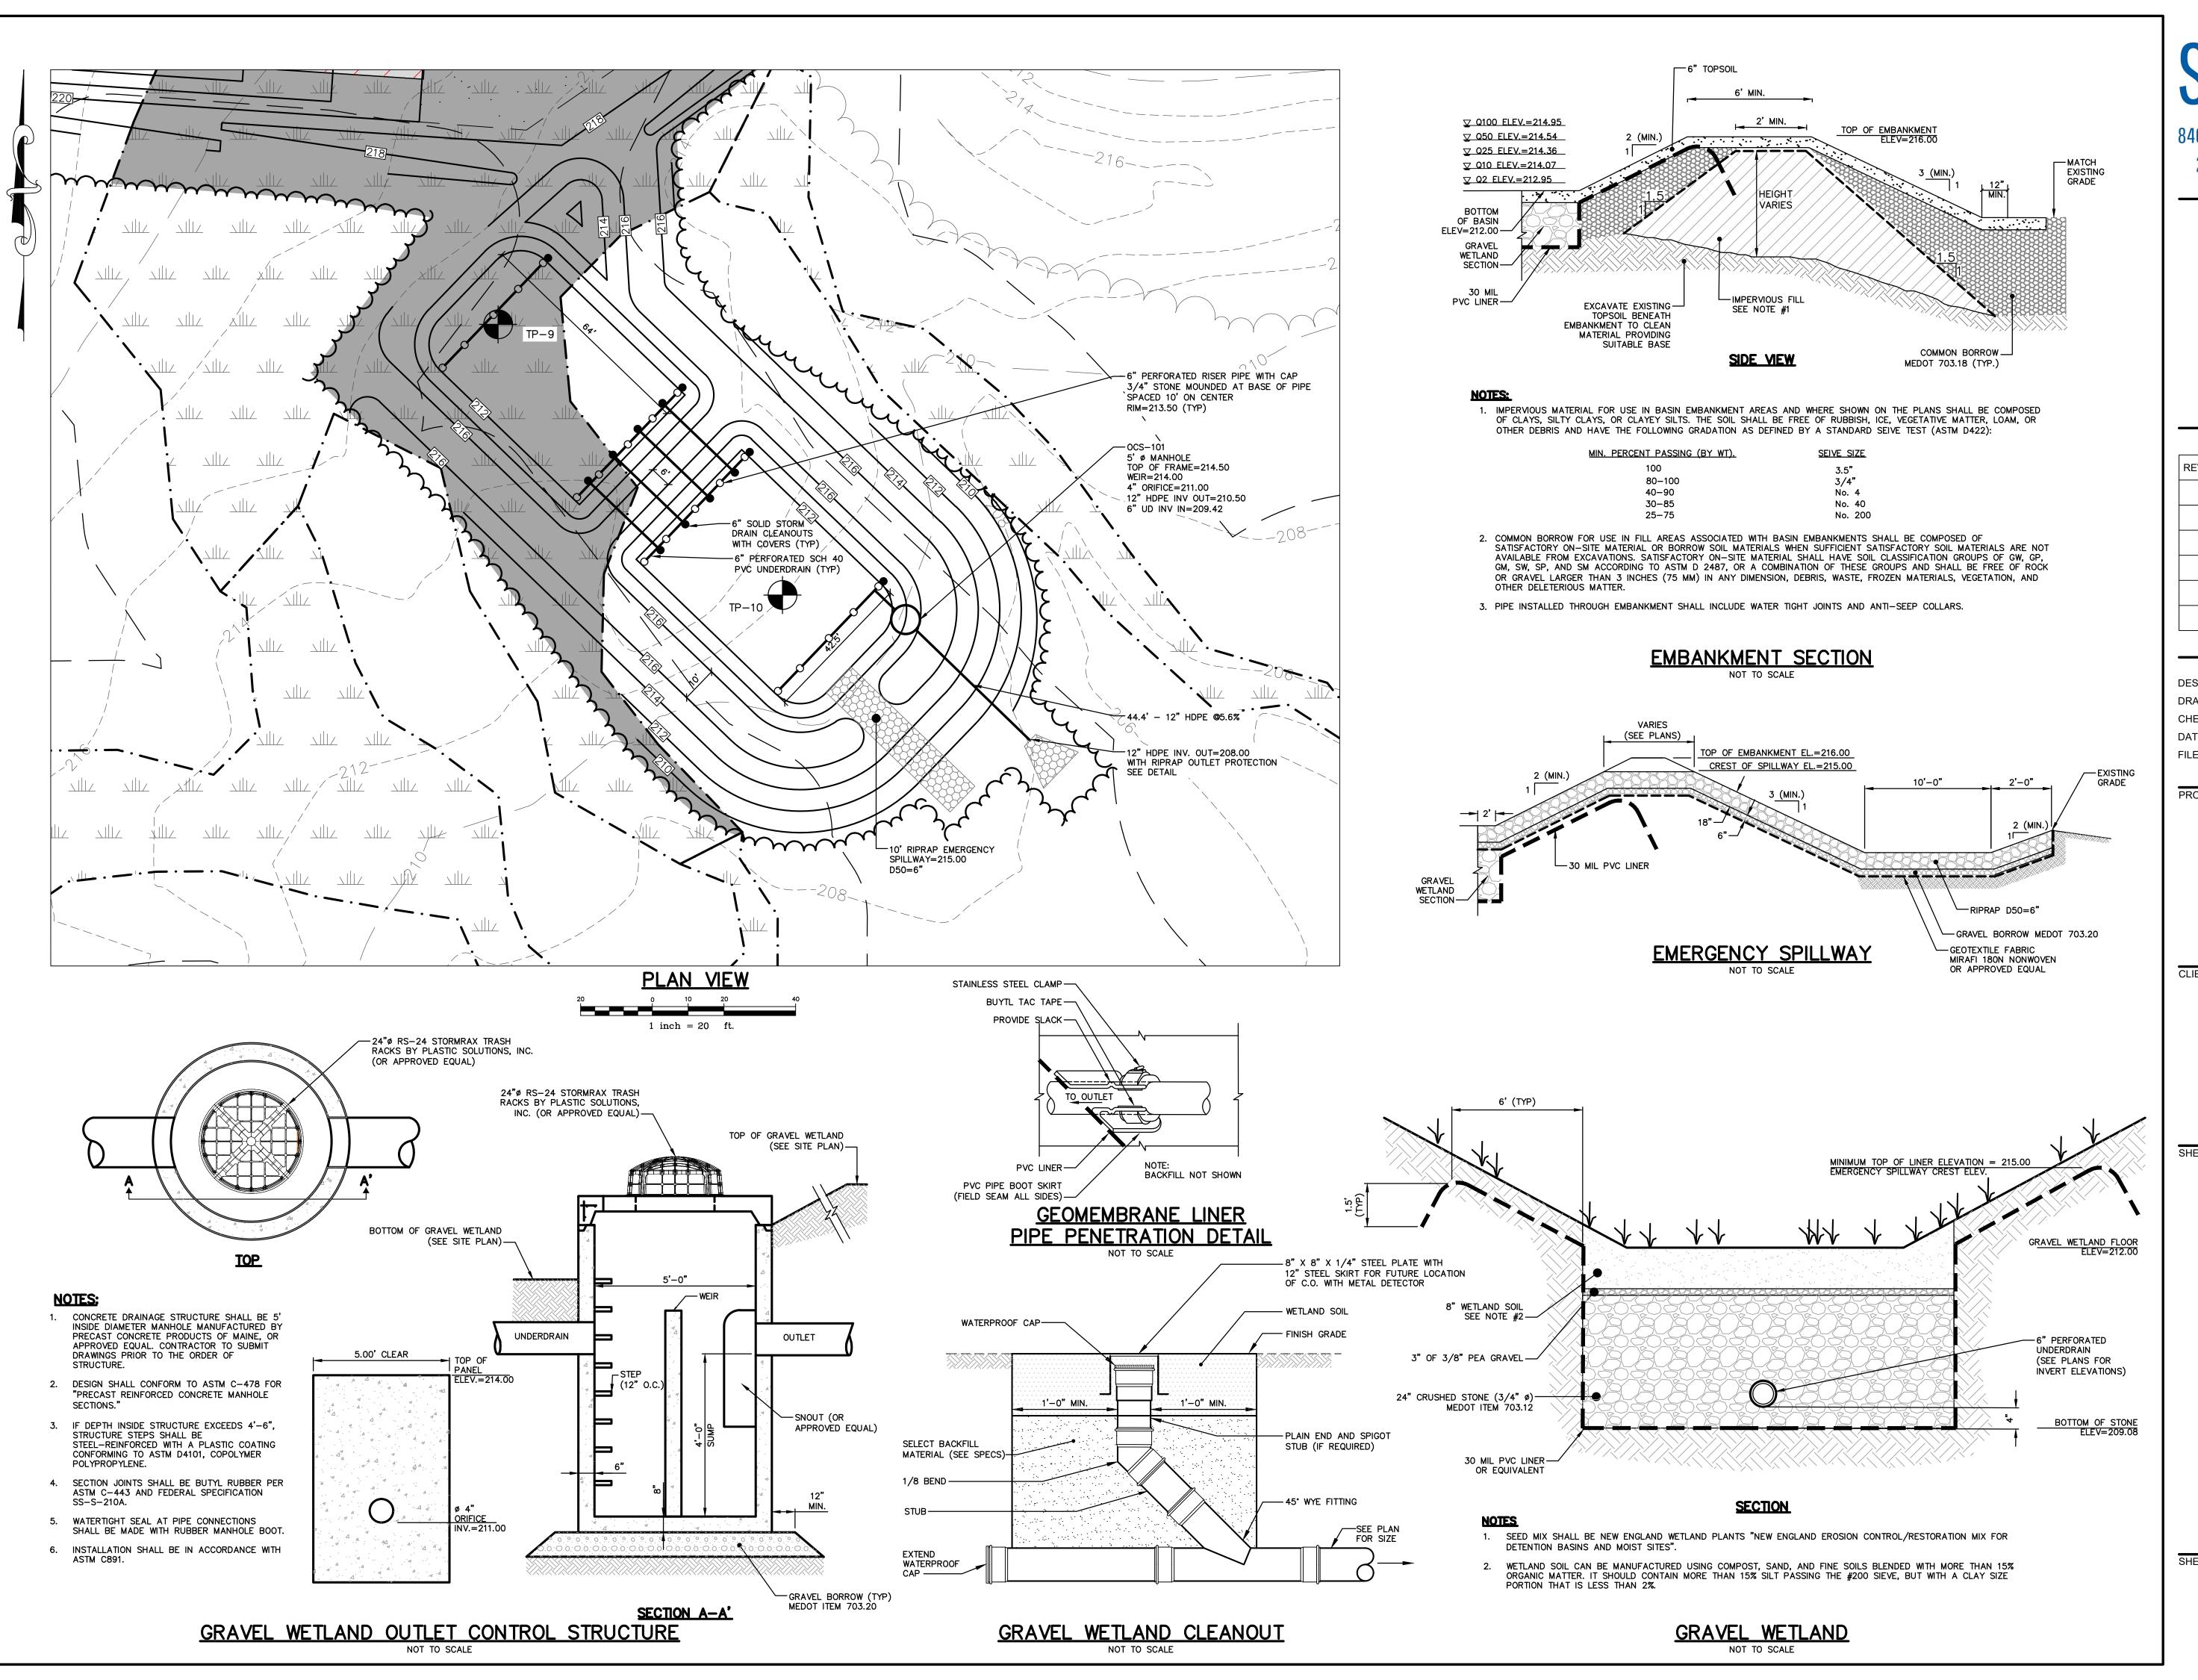
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GARDINER TRANSFER COMPANY, LLC PO BOX 3541 PORTLAND, MAINE

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GRADING,
DRAINAGE,
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EROSION
CONTROL PLAN

SHEET NO:





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PROJECT NAME:

LOT 22 LIBBY HILL BUSINESS PARK **12 TROIANO WAY** GARDINER, MAINE

CLIENT:

GARDINER TRANSFER COMPANY, LLC PO BOX 3541 PORTLAND, MAINE

SHEET TITLE:

GRAVEL WETLAND **PLAN**

SHEET NO:

EROSION AND SEDIMENTATION CONTROL NOTES

TEMPORARY EROSION AND SEDIMENTATION CONTROL MEASURES INCLUDE THE USE OF SEDIMENT BARRIER, EROSION CONTROL MIX, STONE CHECK DAMS, HAY BALE BARRIERS, CATCH BASIN INLET BARRIERS, CATCH BASIN SEDIMENT COLLECTION BAGS, EROSION CONTROL BLANKET, AND TEMPORARY SEEDING AND MULCHING AS REQUIRED. PERMANENT DEVICES INCLUDE THE USE OF RIP RAP AT EXPOSED STORM DRAIN AND CULVERT INLETS AND OUTLETS, RIP RAPPED SLOPES, AND PERMANENT VEGETATION.

A CENERA

- IT IS ANTICIPATED THAT CONSTRUCTION WILL BEGIN IN THE SPRING OF 2023 FOLLOWING RECEIPT OF NECESSARY PERMITS.
- 2. THE PROJECT SHALL CONFORM TO THE DEPARTMENT OF ENVIRONMENTAL PROTECTION STANDARDS PERFORMANCE FOR EXCAVATIONS FOR CLAY, TOPSOIL OR SILT IN ACCORDANCE WITH STATE EROSION CONTROL LAW 38 MRSA 420-C.
- ALL SOIL EROSION AND SEDIMENT CONTROL MEASURES SHALL BE CONSTRUCTED AND MAINTAINED IN ACCORDANCE WITH THE MAINE EROSION AND SEDIMENT CONTROL HANDBOOK FOR CONSTRUCTION: BEST MANAGEMENT PRACTICES (BMP) PUBLISHED BY THE CUMBERLAND COUNTY SOIL AND WATER CONSERVATION DISTRICT AND THE DEPARTMENT OF ENVIRONMENTAL PROTECTION, MAY 2003, OR AS CURRENTLY REVISED.
- 4. ANY CONTRACTOR EROSION AND SEDIMENTATION CONTROL DEEMED NECESSARY BY THE OWNER'S REPRESENTATIVE, DEPARTMENT OF ENVIRONMENTAL PROTECTION (DEP)
 PERSONNEL AND/OR MUNICIPAL OFFICIALS SHALL BE INSTALLED.
- PERSONNEL AND/OR MUNICIPAL OFFICIALS SHALL BE INSTALLED.

 5. THE CONTRACTOR IS RESPONSIBLE FOR ALL FINES RESULTING DURING CONSTRUCTION FROM EROSION OR SEDIMENTATION FROM THE SITE TO SURROUNDING PROPERTIES, WATER BODIES, OR
- 6. THE CONTRACTOR SHALL BE RESPONSIBLE FOR THE REPAIR/REPLACEMENT/MAINTENANCE OF ALL EROSION CONTROL MEASURES UNTIL ALL DISTURBED AREAS ARE STABILIZED TO THE SATISFACTION OF THE ABOVE PERSONNEL. DESCRIPTIONS OF ACCEPTABLE PERMANENT STABILIZATION FOR VARIOUS COVER TYPES FOLLOWS:
- A. FOR SEEDED AREAS, PERMANENT STABILIZATION MEANS 90% COVERAGE OF THE DISTURBED AREA WITH MATURE, HEALTHY PLANTS WITH NO EVIDENCE OF WASHING OR RILLING OF THE
- FOR SODDED AREAS, PERMANENT STABILIZATION MEANS THE COMPLETE BINDING OF THE SOD ROOTS INTO THE UNDERLYING SOIL WITH NO SLUMPING OF THE SOD OR DIE-OFF.

 FOR MULCHED AREAS, PERMANENT MULCHING MEANS TOTAL COVERAGE OF THE EXPOSED AREA WITH MULCH. EROSION CONTROL MIX MAY BE USED AS MULCH FOR PERMANENT

STABILIZATION ACCORDING TO THE BMP APPLICATION RATES AND LIMITATIONS.

- FOR AREAS STABILIZED WITH RIP RAP, PERMANENT STABILIZATION MEANS THAT SLOPES STABILIZED WITH RIP RAP HAVE AN APPROPRIATE BACKING OF A WELL—GRADED GRAVEL OR GEOTEXTILE TO PREVENT SOIL MOVEMENT FROM BEHIND THE RIP RAP. STONE MUST BE SIZED APPROPRIATELY.
- E. FOR PAVED AREAS, PERMANENT STABILIZATION MEANS THE PLACEMENT OF THE COMPACTED
- FOR OPEN CHANNELS, PERMANENT STABILIZATION MEANS THE CHANNEL IS STABILIZED WITH MATURE VEGETATION AT LEAST THREE INCHES IN HEIGHT, WITH WELL-GRADED RIP RAP, OR WITH ANOTHER NON-EROSIVE LINING CAPABLE OF WITHSTANDING THE ANTICIPATED FLOW VELOCITIES AND FLOW DEPTHS WITHOUT RELIANCE ON CHECK DAMS TO SLOW FLOW. THERE MUST BE NO EVIDENCE OF SLUMPING OF THE LINING, UNDERCUTTING OF THE BANKS, OR DOWN CUTTING OF THE CHANNEL.

B. EROSION AND SEDIMENTATION CONTROL MEASURES

WETLANDS AS A RESULT OF THIS PROJECT.

- . REMOVAL OF SOD, TREES, BUSHES AND OTHER VEGETATION AND SOIL DISTURBANCE WILL BE KEPT TO A MINIMUM WHILE ALLOWING PROPER SITE DEVELOPMENT.
- 2. GRUBBINGS AND ANY UNUSABLE TOPSOIL SHALL BE STRIPPED AND REMOVED FROM THE PROJECT SITE AND DISPOSED OF IN AN APPROVED MANNER.
- 3. ANY SUITABLE TOPSOIL WILL BE STRIPPED AND STOCKPILED FOR REUSE IN FINAL GRADING. TOPSOIL WILL BE STOCKPILED IN A MANNER SUCH THAT NATURAL DRAINAGE IS NOT OBSTRUCTED AND NO OFF—SITE SEDIMENT DAMAGE WILL RESULT. IF A STOCKPILE IS NECESSARY, THE SIDE SLOPES OF THE TOPSOIL STOCKPILE WILL NOT EXCEED 2:1. TOPSOIL STOCKPILES WILL BE TEMPORARILY SEEDED WITH AROOSTOOK RYE, ANNUAL OR PERENNIAL RYE GRASS (DEPENDING ON DATE SEEDED) WITHIN 7 DAYS OF FORMATION, OR TEMPORARILY MULCHED IF SEEDING CANNOT BE DONE WITHIN THE RECOMMENDED SEEDING DATES.
- 4. TEMPORARY DIVERSION BERMS AND DRAINAGE SWALES SHALL BE CONSTRUCTED AS
- TEMPORARY STABILIZATION SHALL BE CONDUCTED WITHIN 7 DAYS OF INITIAL DISTURBANCE OF SOILS, PRIOR TO ANY RAIN EVENT, AND PRIOR TO ANY WORK SHUT DOWN LASTING MORE THAN ONE DAY. TEMPORARY STABILIZATION INCLUDES SEED, MULCH, OR OTHER NON-ERODABLE COVER. AREAS WITHIN 75 FEET OF WETLANDS SHALL BE TEMPORARILY STABILIZED WITHIN 48 HOURS OR PRIOR TO RAIN EVENT.
- APPLY HAY OR STRAW MULCH AT A RATE OF 2 TONS PER ACRE, AND ANCHOR AS NECESSARY.
 TEMPORARY SEEDING SPECIFICATIONS. WHERE THE SEED BED HAS BEEN COMPACTED BY CONSTRUCTION OPERATIONS, LOOSEN SOIL TO A DEPTH OF 4 INCHES BEFORE APPLYING SEED. UNIFORMLY APPLY SEED AT THE RECOMMENDED SEEDING RATES AND DATES, APPLY HAY OR STRAW MULCH AT A RATE OF 2 TONS PER ACRE, AND ANCHOR AS NECESSARY.
- RECOMMENDED TEMPORARY SEEDING DATES AND APPLICATION RATES ARE AS FOLLOWS:

 AROOSTOOK RYE: RECOMMENDED SEEDING DATES: 8/15 10/1
 APPLICATION RATE: 112 LBS./ACRE
- ANNUAL RYE GRASS: RECOMMENDED SEEDING DATES: 4/1 7/1 APPLICATION RATE: 40 LBS./ACRE
- PERENNIAL RYE GRASS: RECOMMENDED SEEDING DATES: 8/15 9/15 APPLICATION RATE: 40 LBS./ACRE
- 8. IF THE AREA WILL REMAIN UNWORKED FOR MORE THAN ONE YEAR OR HAS BEEN BROUGHT TO STABILIZATION USING VEGETATION THROUGH PLANTING, SEEDING, SOD, OR THROUGH THE USE OF PERMANENT MULCH OR RIP RAP. IF USING VEGETATION FOR STABILIZATION, SELECT THE PROPER VEGETATION FOR THE LIGHT, MOISTURE, AND SOIL CONDITIONS. AMEND AREAS OF DISTURBED SUBSOIL WITH TOP SOIL OR OTHER ORGANIC AMENDMENTS, PROTECT SEEDED AREAS WITH MULCH OR, IF NECESSARY EROSION CONTROL BLANKETS, AND SCHEDULE SODDING, PLANTING, AND SEEDING SO TO AVOID DIE—OFF FROM SUMMER DROUGHT AND FALL FROSTS. NEWLY SEEDED OR SODDED AREAS MUST BE PROTECTED FROM VEHICLE TRAFFIC, EXCESSIVE PEDESTRIAN TRAFFIC, AND CONCENTRATED RUNOFF UNTIL THE VEGETATION IS WELL ESTABLISHED. AREAS MUST BE REWORKED AND RESTABILIZED IF GERMINATION IS SPARSE, PLANT COVERAGE IS SPOTTY, OR TOPSOIL EROSION IS EVIDENT.
- 9. PERMANENT SEEDING SPECIFICATION. IF A LANDSCAPE PLAN HAS BEEN PREPARED FOR THE PROJECT, SOIL PREPARATION AND SEEDING SPECIFICATIONS OF THAT PLAN SHALL SUPERSEDE THESE GENERAL PERMANENT SEEDING SPECIFICATIONS. IT IS RECOMMENDED THAT PERMANENT SEEDING BE COMPLETED BETWEEN APRIL 1 AND AUGUST 15 OF EACH YEAR. LATE SEASON SEEDING MAY BE DONE BETWEEN AUGUST 15 AND SEPTEMBER 15. AREAS NOT SEEDED OR WHICH DO NOT OBTAIN A SATISFACTORY GROWTH BY OCTOBER 1 SHALL BE SEEDED WITH AROOSTOOK RYE OR MULCHED AT RATES PREVIOUSLY SPECIFIED. SEE WINTER CONDITIONS NOTES FOR SEEDING STABILIZATION AFTER NOVEMBER 1.
- A. APPLY TOPSOIL TO A MINIMUM DEPTH OF 6 INCHES. MIX TOPSOIL WITH THE SUBSOIL TO A MINIMUM DEPTH OF 6 INCHES.
- B. UNIFORMLY APPLY SEED MIXTURE AT THE RECOMMENDED SEEDING RATES AND DATES, APPLY HAY OR STRAW MULCH AT A RATE OF 2 TONS PER ACRE, AND ANCHOR AS
- THE SEED MIXTURE FOR LAWN AREAS SHALL CONSIST OF SEEDS PROPORTIONED BY WEIGHT AS FOLLOWS:

10 % CREEPING RED FESCUE 30 % KENTUCKY BLUEGRASS 60 % PERENNIAL RYE GRASS

- D. THE SEED MIXTURE FOR WET AREAS SHALL CONSIST OF SEEDS PROPORTIONED BY WEIGHT AS FOLLOWS:

 50 % REED CANARY GRASS
 - 25 % RED TOP 15 % CREEPING RED FESCUE 10 % PERENNIAL RYE GRASS
- 10. MULCH ALL AREAS SEEDED SO THAT SOIL IS NOT VISIBLE THROUGH THE MULCH.
 11. DITCH LININGS, STONE CHECK DAMS, AND RIP RAP INLET AND OUTLET PROTECTION SHALL BE INSTALLED WITHIN 48 HOURS OF COMPLETING THE GRADING OF THAT SECTION OF DITCH OR INSTALLATION OF CULVERT.
- 12. RIP RAP REQUIRED AT CULVERTS AND STORM DRAIN INLETS AND OUTLETS SHALL CONSIST OF FIELD STONE OR ROUGH UNHEWN QUARRY STONE OF APPROXIMATELY RECTANGULAR SHAPE. STONES SHALL WEIGH FROM 10 LBS. TO 200 LBS. AND 50% OF THE STONES BY VOLUME SHALL EXCEED A UNIT WEIGHT OF APPROXIMATELY 50 LBS.
- 13. EROSION CONTROL BLANKET SHALL BE INSTALLED ON ALL PERMANENT SLOPES STEEPER THAN 3:1, IN THE BASE OF DITCHES NOT OTHERWISE PROTECTED, AND ANY DISTURBED AREAS WITHIN 100 FEET OF A PROTECTED NATURAL RESOURCE (E.G. WETLANDS AND WATER BODIES). EROSION CONTROL BLANKET SHALL BE INSTALLED IN ACCORDANCE WITH MANUFACTURER'S RECOMMENDATIONS.
- 4. TEMPORARY CONTROL MEASURES SHALL BE REMOVED WITHIN 30 DAYS AFTER PERMANENT STABILIZATION IS ATTAINED.

. HOUSEKEEPING

- 1. SPILL PREVENTION. CONTROLS MUST BE USED TO PREVENT POLLUTANTS FROM BEING DISCHARGED FROM MATERIALS ON SITE, INCLUDING STORAGE PRACTICES TO MINIMIZE EXPOSURE OF THE MATERIALS TO STORM WATER, AND APPROPRIATE SPILL PREVENTION, CONTAINMENT, AND RESPONSE PLANNING AND IMPLEMENTATION.
- 2. GROUNDWATER PROTECTION. DURING CONSTRUCTION, LIQUID PETROLEUM PRODUCTS AND OTHER HAZARDOUS MATERIALS WITH THE POTENTIAL TO CONTAMINATE GROUNDWATER MAY NOT BE STORED OR HANDLED IN AREAS OF THE SITE DRAINING TO AN INFILTRATION AREA. AN "INFILTRATION AREA" IS ANY AREA OF THE SITE THAT BY DESIGN OR AS A RESULT OF SOILS, TOPOGRAPHY AND OTHER RELEVANT FACTORS, ACCUMULATES RUNOFF THAT INFILTRATES INTO THE SOIL. DIKES, BERMS, SUMPS, AND OTHER FORMS OF SECONDARY CONTAINMENT THAT PREVENT DISCHARGE TO GROUNDWATER MAY BE USED TO ISOLATE PORTIONS OF THE SITE FOR THE PURPOSES OF STORAGE AND HANDLING OF THESE MATERIALS.
- PREVENT DISCHARGE TO GROUNDWATER MAY BE USED TO ISOLATE PORTIONS OF THE SITE FOR THE PURPOSES OF STORAGE AND HANDLING OF THESE MATERIALS.

 3. FUGITIVE SEDIMENT AND DUST. ACTIONS MUST BE TAKEN TO ENSURE THAT ACTIVITIES DO NOT RESULT IN NOTICEABLE EROSION OF SOILS OR FUGITIVE DUST EMISSIONS DURING OR AFTER
- 4. DEBRIS AND OTHER MATERIAL. LITTER, CONSTRUCTION DEBRIS, AND CONSTRUCTION CHEMICALS EXPOSED TO STORM WATER, MUST BE PREVENTED FROM BECOMING A POLLUTANT SOURCE.

CONSTRUCTION. OIL MAY NOT BE USED FOR DUST CONTROL.


5. TRENCH OR FOUNDATION DE-WATERING. TRENCH DE-WATERING IS THE REMOVAL OF WATER FROM TRENCHES, FOUNDATIONS, COFFER DAMS, PONDS AND OTHER AREAS WITHIN THE CONSTRUCTION AREA THAT RETAIN WATER AFTER EXCAVATION. THE COLLECTED WATER REMOVED FROM THE PONDED AREA, MUST BE FILTERED THROUGH A DIRT BAG, HAYBALE CORRAL OR OTHER SILTATION

D. INSPECTION AND MAINTENANCE

- INSPECT DISTURBED AND IMPERVIOUS AREAS, EROSION AND STORMWATER CONTROL MEASURES, AREAS USED FOR STORAGE THAT ARE EXPOSED TO PRECIPITATION, AND LOCATIONS WHERE VEHICLES ENTER OR EXIT THE SITE AT LEAST ONCE A WEEK AS WELL AS BEFORE AND AFTER STORM EVENTS, PRIOR TO COMPLETION OF PERMANENT STABILIZATION. A PERSON WITH KNOWLEDGE OF EROSION AND STORM WATER CONTROLS, INCLUDING THE STANDARDS IN THE MAINE CONSTRUCTION GENERAL PERMIT AND ANY DEP OR MUNICIPAL COMPANION DOCUMENTS, MUST CONDUCT THE INSPECTION. THIS PERSON MUST BE IDENTIFIED IN THE INSPECTION LOG. IF BEST MANAGEMENT PRACTICES BMPS NEED TO BE MODIFIED OR IF ADDITIONAL BMPS ARE NECESSARY, IMPLEMENTATION MUST BE COMPLETED WITHIN 7 CALENDAR DAYS AND PRIOR TO ANY STORM EVENT (RAINFALL). ALL MEASURES MUST BE MAINTAINED IN EFFECTIVE OPERATING CONDITION UNTIL AREAS ARE PERMANENTLY STABILIZED.
- 2. AN INSPECTION AND MAINTENANCE LOG MUST BE KEPT SUMMARIZING THE SCOPE OF THE INSPECTION, NAME AND QUALIFICATIONS OF THE PERSON PERFORMING THE INSPECTION, DATE, AND MAJOR OBSERVATIONS RELATING TO OPERATION OF EROSION AND SEDIMENTATION CONTROLS AND POLLUTION PREVENTION MEASURES. MAJOR OBSERVATIONS MUST INCLUDE: BMPS THAT NEED TO BE MAINTAINED, LOCATION(S) OF BMPS THAT FAILED TO OPERATE AS DESIGNED OR PROVED INADEQUATE FOR A PARTICULAR LOCATION, AND LOCATION(S) WHERE ADDITIONAL BMPS ARE NEEDED THAT DID NOT EXIST AT THE TIME OF THE INSPECTION. FOLLOW—UP TO CORRECT DEFICIENCIES OR ENHANCE CONTROLS MUST ALSO BE INDICATED IN THE LOG AND DATED; INCLUDING WHAT ACTION WAS TAKEN AND WHEN.


E. WINTER CONSTRUCTION EROSION AND SEDIMENTATION CONTROL NOTES

- THE WINTER CONSTRUCTION PERIOD TYPICALLY BEGINS IN EARLY NOVEMBER AND ENDS IN MID APRIL. IF A CONSTRUCTION SITE IS NOT STABILIZED WITH PAVEMENT, A ROAD GRAVEL BASE, 75% MATURE VEGETATION COVER, OR RIPRAP BY NOVEMBER 15 THEN THE SITE NEEDS TO BE PROTECTED WITH OVER—WINTER STABILIZATION. WINTER EXCAVATION AND EARTHWORK SHALL BE COMPLETED SUCH THAT NO MORE THAN 1 ACRE OF THE SITE IS WITHOUT STABILIZATION AT ANY ONE TIME. LIMIT THE EXPOSED AREA TO THOSE AREAS IN WHICH WORK IS TO OCCUR DURING THE FOLLOWING 15 DAYS AND THAT CAN BE MULCHED IN ONE DAY PRIOR TO ANY SNOW EVENT. AN AREA SHALL BE CONSIDERED DENUDED UNTIL THE SUBBASE GRAVEL IS INSTALLED IN THE ROADWAY AREAS OR THE AREAS OF FUTURE LOAM AND SEED HAVE BEEN LOAMED, SEEDED, AND MULCHED. A COVER OF EROSION CONTROL MIX IS THE PREFERRED TEMPORARY MULCH DURING WINTER CONDITIONS.
- NATURAL RESOURCE PROTECTION: ANY AREAS WITHIN 75 FEET FROM ANY REGULATED NATURAL RESOURCES, IF NOT STABILIZED WITH A MINIMUM OF 75% MATURE VEGETATION CATCH, SHALL BE MULCHED BY DECEMBER 1 AND ANCHORED WITH PLASTIC NETTING OR PROTECTED WITH AN EROSION CONTROL COVER. DURING WINTER CONSTRUCTION, A DOUBLE ROW OF SEDIMENT BARRIERS (FOR EXAMPLE, SILT FENCE BACKED WITH HAY BALES OR EROSION CONTROL MIX) WILL BE PLACED BETWEEN ANY REGULATED NATURAL RESOURCE AND THE DISTURBED AREA. PROJECTS CROSSING THE REGULATED NATURAL RESOURCE SHALL BE PROTECTED A MINIMUM DISTANCE OF 100 FEET ON EITHER SIDE FROM THE RESOURCE. EXISTING PROJECTS NOT STABILIZED BY DECEMBER 1 SHALL BE PROTECTED WITH THE SECOND LINE OF SEDIMENT BARRIER TO ENSURE FUNCTIONALITY DURING THE SPRING THAW AND RAINS.
- 2. <u>SEDIMENT BARRIERS</u>: DURING FROZEN CONDITIONS, SEDIMENT BARRIERS MAY CONSIST OF EROSION CONTROL MIX BERMS OR ANY OTHER RECOGNIZED SEDIMENT BARRIERS AS FROZEN SOIL PREVENTS THE PROPER INSTALLATION OF HAY BALES OR SILT FENCES.
- MULCHING: ALL AREAS SHALL BE CONSIDERED TO BE DENUDED UNTIL SEEDED AND MULCHED. HAY AND STRAW MULCH SHALL BE APPLIED AT A RATE OF 3 TONS PER ACRE (TWICE THE NORMAL ACCEPTED RATE) AND SHALL BE PROPERLY ANCHORED. EROSION CONTROL MIX MUST BE APPLIED WITH A MINIMUM 4 INCHES THICKNESS. MULCH SHALL NOT BE SPREAD ON TOP OF SNOW. SNOW MUST BE REMOVED DOWN TO A ONE—INCH DEPTH PRIOR TO APPLICATION. AFTER EACH DAY OF FINAL GRADING, THE AREA WILL BE PROPERTY STABILIZED WITH ANCHORED HAY OR STRAW OR EROSION CONTROL MATTING. AN AREA SHALL BE CONSIDERED TO HAVE BEEN STABILIZED WHEN EXPOSED SURFACES HAVE BEEN EITHER MULCHED OR ADEQUATELY ANCHORED SO THAT GROUND SURFACE IS NOT VISIBLE THROUGH THE MULCH. BETWEEN THE DATES OF NOVEMBER 1 AND APRIL 15, ALL MULCH SHALL BE ANCHORED BY EITHER MULCH NETTING, ASPHALT EMULSION CHEMICAL, TRACKING OR WOOD CELLULOSE FIBER. THE COVER WILL BE CONSIDERED SUFFICIENT WHEN THE GROUND SURFACE IS NOT VISIBLE THROUGH THE MULCH. AFTER NOVEMBER 1ST, MULCH AND ANCHORING OF ALL EXPOSED SOIL SHALL OCCUR AT THE END OF EACH FINAL GRADING WORKDAY.
- 4. <u>SOIL STOCKPILING</u>: STOCKPILES OF SOIL OR SUBSOIL WILL BE MULCHED FOR OVER WINTER PROTECTION WITH HAY OR STRAW AT TWICE THE NORMAL RATE OR WITH A FOUR-INCH LAYER OF EROSION CONTROL MIX. THIS WILL BE DONE WITHIN 24 HOURS OF STACKING AND RE-ESTABLISHED PRIOR TO ANY RAINFALL OR SNOWFALL. ANY SOIL STOCKPILE WILL NOT BE PLACED WITHIN 100 FEET FROM ANY REGULATED NATURAL RESOURCE.
- 5. <u>SEEDING</u>: BETWEEN THE DATES OF OCTOBER 15 AND APRIL 1, LOAM OR SEED WILL NOT BE REQUIRED. DURING PERIODS OF ABOVE FREEZING TEMPERATURES FINISHED AREAS SHALL BE FINE GRADED AND EITHER PROTECTED MULCH OR TEMPORARILY SEEDED AND MULCHED UNTIL SUCH TIME AS THE FINAL TREATMENT CAN BE APPLIED. IF THE DATE IS AFTER NOVEMBER 1 AND IF THE EXPOSED AREA HAS BEEN LOOMED, FINAL GRADED WITH A UNIFORM SURFACE, THEN THE AREA MAY BE DORMANT SEEDED AT A RATE OF 3 TIMES HIGHER THAN SPECIFIED FOR PERMANENT SEED AND THEN MULCHED. IF DORMANT SEEDING IS USED, ALL DISTURBED AREAS SHALL RECEIVE 4 INCHES OF LOAM AND SEED AT AN APPLICATION RATE OF 5 LBS PER 1,000 S.F. ALL AREAS INSUFFICIENTLY VEGETATED (LESS THAN 75%) IN THE SPRING SHALL BE REVEGETATED.
- 6. OVER-WINTER STABILIZATION OF DITCHES AND CHANNELS: ALL STONE-LINED DITCHES AND CHANNELS MUST BE CONSTRUCTED BY NOVEMBER 1. ALL GRASS-LINED DITCHES AND CHANNELS MUST BE CONSTRUCTED AND STABILIZED BY SEPTEMBER 1. IF A GRASS-LINED DITCH OR CHANNEL IS STABILIZED BY SEPTEMBER 1, THEN EITHER A SOD LINING SHALL BE INSTALLED PRIOR TO OCTOBER 1 OR THE DITCH MUST BE LINED WITH STONE RIPRAP BACKED BY AN APPROPRIATE GRAVEL BED OR GEOTEXTILE PRIOR TO NOVEMBER 1.
- 7. OVER-WINTER STABILIZATION OF DISTURBED SLOPES: ALL STONE-COVERED SLOPES MUST BE CONSTRUCTED AND STABILIZED BY NOVEMBER 15. ALL SLOPES TO BE VEGETATED MUST BE SEEDED AND MULCHED BY SEPTEMBER 1. ALL AREAS HAVING A GRADE STEEPER THAN 8% SHALL BE CONSIDERED A SLOPE. IF A SLOPE TO BE VEGETATED IS NOT STABILIZED BY SEPTEMBER 1, THEN THE SLOPE SHALL EITHER BE STABILIZED WITH TEMPORARY VEGETATION AND EROSION CONTROL MATS BY OCTOBER 1, SOD BY OCTOBER 1, EROSION CONTROL MIX BY NOVEMBER 1, OR STONE RIPRAP BY NOVEMBER 15. SEE APPLICABLE SECTIONS UNDER EROSION AND SEDIMENTATION CONTROL NOTES FOR PROPER INSTALLATION METHODS.
- 8. OVER-WINTER STABILIZATION OF DISTURBED SOILS: BY SEPTEMBER 15, ALL DISTURBED SOILS ON AREAS HAVING A SLOPE LESS THAN 15% MUST BE SEEDED AND MULCHED. IF THE DISTURBED AREAS ARE NOT STABILIZED BY THIS DATE, THEN THE AREA SHALL EITHER BE STABILIZED WITH TEMPORARY VEGETATION BY OCTOBER 1, SOD BY OCTOBER 1, OR MULCH BY NOVEMBER 15. SEE APPLICABLE SECTIONS UNDER EROSION AND SEDIMENTATION CONTROL NOTES FOR PROPER INSTALLATION METHODS.
- 9. MAINTENANCE: MAINTENANCE MEASURES SHALL BE APPLIED AS NEEDED DURING THE ENTIRE CONSTRUCTION SEASON. AFTER EACH RAINFALL, SNOW STORM OR PERIOD OF THAWING AND RUNOFF, THE SITE CONTRACTOR SHALL PERFORM A VISUAL INSPECTION OF ALL INSTALLED EROSION CONTROL MEASURES AND PERFORM REPAIRS AS NEEDED TO INSURE THEIR CONTINUOUS FUNCTION. FOLLOWING THE TEMPORARY AND/OR FINAL SEEDING AND MULCHING, THE CONTRACTOR SHALL, IN THE SPRING, INSPECT AND REPAIR ANY DAMAGES AND/OR BARE SPOTS. AN ESTABLISHED VEGETATIVE COVER MEANS A MINIMUM OF 85% OF AREAS VEGETATED WITH VIGOROUS GROWTH.

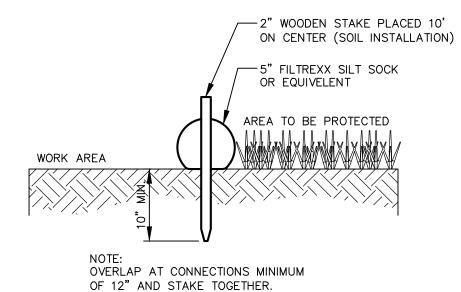

SECTION VIEW

SEDIMENT BARRIER (SILT SOCK)

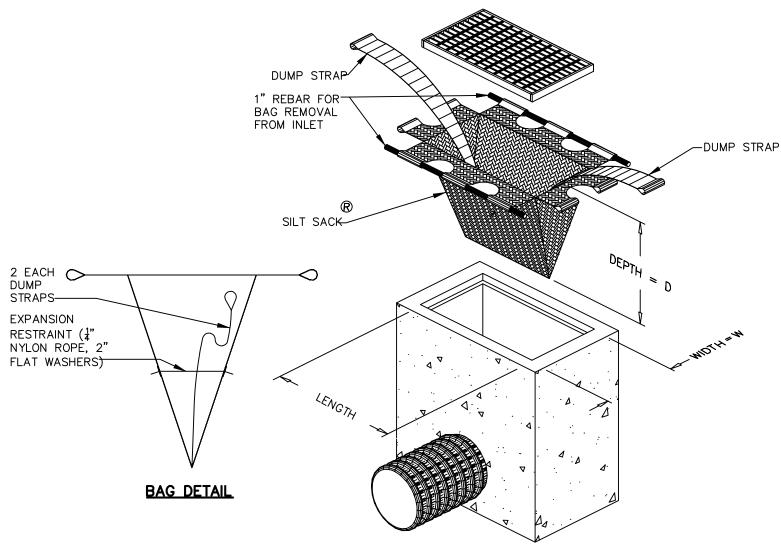


MAINTENANCE SCHEDULE:


- 1. EACH SILTSACK SHOULD BE INSPECTED AFTER EVERY MAJOR RAIN EVENT.
 2. IF THERE HAVE BEEN NO MAJOR EVENTS, SILTSACKS SHALL BE INSPECTED
- EVERY 2-3 WEEKS.

 3. THE YELLOW RESTRAINT CORD SHOULD BE VISIBLE AT ALL TIMES. IF THE CORD


IS COVERED WITH SEDIMENT, THE SILTSACK SHOULD BE EMPTIED.

SILTSACK DETAIL

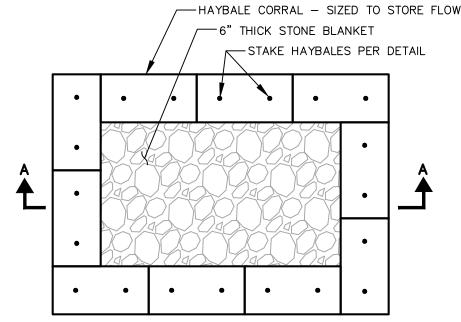

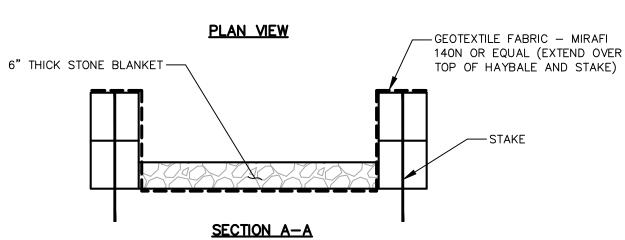


TEMPORARY HAYBALE CORRAL SEDIMENT BASIN

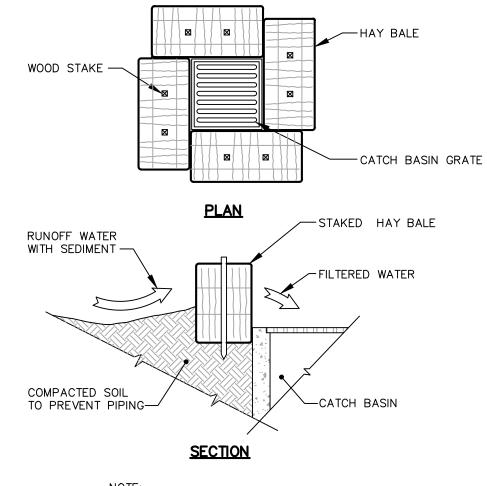

NOTE: INSTALL BARRIER AT CATCH BASIN IF GRATE IS SET FLUSH WITH WORKING GRADE.


CATCH BASIN HAY BALE BARRIER

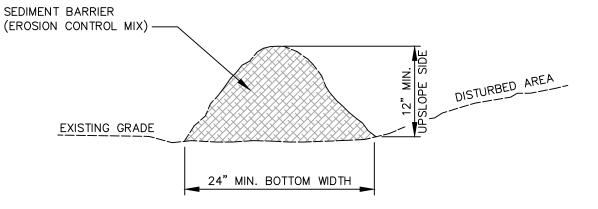

IN ORDER FOR EROSION CONTROL MIX TO BE USED IN LIEU OF SILT FENCE IT MUST MEET THE FOLLOWING STANDARDS:

- 1. THE ORGANIC MATTER CONTENT SHALL BE BETWEEN 50 AND 100%, DRY WEIGHT BASIS.
- 2. PARTICLE SIZE BY WEIGHT SHALL BE 100% PASSING A 6" SCREEN AND A MINIMUM OF 70%, MAXIMUM OF 85%, PASSING A 0.75" SCREEN.
- 3. THE ORGANIC PORTION NEEDS TO BE FIBROUS AND ELONGATED.
- 4. LARGE PORTIONS OF SILTS, CLAYS OR FINE SANDS ARE NOT ACCEPTABLE IN THE MIX.
- 5. SOLUBLE SALTS CONTENT SHALL BE <4.0 mmhos/cm.
- 6. THE pH SHOULD FALL BETWEEN 5.0 AND 8.0.
- 7. THE EROSION CONTROL MIX SHALL CONTAIN A WELL GRADED MIXTURE OF PARTICLE SIZES AND MAY CONTAIN ROCKS LESS THAN 4" DIAMETER. EROSION CONTROL MIX MUST BE FREE OF REFUSE, PHYSICAL CONTAMINANTS, AND MATERIAL TOXIC TO PLANT GROWTH.
- PLACE BARRIER ALONG A RELATIVELY FLAT CONTOUR. CUT TALL GRASSES OR WOODY VEGETATION TO AVOID CREATING VOIDS AND BRIDGES WHERE FINES CAN WASH UNDER THE BARRIER THROUGH GRASS BLADES AND BRANCHES.
- 9. PLACEMENT OF BARRIER SHOULD BE:
 AT TOE OF THE SLOPE.
- ON FROZEN GROUND, BEDROCK OR ROOTED FORESTED AREAS.
 AT THE EDGE OF GRAVEL AND AREAS UNDER CONSTRUCTION.
- 10. BARRIER SHALL NOT BE USED ADJACENT TO WETLANDS
- 11. REMOVE SEDIMENT DEPOSITS WHEN THEY REACH APPROXIMATELY ONE HALF THE HEIGHT OF THE BARRIER.
- 12. WHEN BARRIER IS DECOMPOSED, CLOGGED WITH SEDIMENT, ERODED OR INEFFECTIVE, IT MUST BE REPLACED OR REPAIRED. THE BARRIER SHOULD BE RESHAPED AS

SEDIMENT BARRIER (EROSION CONTROL MIX)

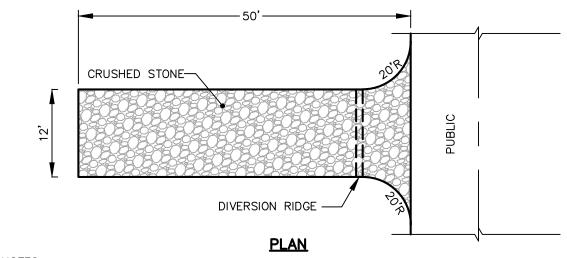

NOTES:


- 1. USE CRUSHED STONE OR ACCEPTABLE ON-SITE MATERIAL. (STONE AGGREGATE SIZE 2"
- GEOTEXTILE FILTER CLOTH SHALL BE PLACED OVER THE ENTIRE AREA TO BE COVERED WITH AGGREGATE. ACCEPTABLE MATERIALS ARE TREVIRA SPUNBOND 1135 MIRAFI 600X, OR EQUIVALENT.
- 3. LENGTH AS SHOWN.
- 4. THICKNESS NOT LESS THAN SIX (6) INCHES.
- 5. PROVIDE APPROPRIATE TRANSISTION BETWEEN STABILIZED CONSTRUCTION ENTRANCE AND PUBLIC RIGHT—OF—WAY. INGRESS OR EGRESS.
- 6. MAINTENANCE THE ENTRANCE SHALL BE MAINTAINED IN A CONDITION WHICH WILL PREVENT TRACKING OR FLOWING OF SEDIMENT ONTO PUBLIC RIGHTS—OF—WAY. THIS MAY REQUIRE PERIODIC REPAIR AND TOP DRESSING WITH ADDITIONAL STONE AS CONDITIONS DEMAND. ALL SEDIMENT SPILLED, DROPPED, WASHED OR TRACKED ONTO PUBLIC RIGHTS—OF—WAY MUST BE REMOVED IMMEDIATELY.
- 7. WHEN COMPLETE, CONTRACTOR TO REMOVE STONE AND GRADE SUBBASE TO MATCH EXISTING OR PROPOSED GRADES. COVER WITH MINIMUM 6—INCH LAYER OF LOAM, APPLY WETLAND SEED MIX WHEN IN FLOODPLAIN (ELEVATION 40 AND BELOW) AND CONSERVATION MIX ABOVE. COVER WITH BIODEGRADABLE DOUBLE NET STRAW MAT.

STABILIZED CONSTRUCTION ENTRANCE

NOT TO SCAL



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EV.	DATE	REVISION DESCRIPTION

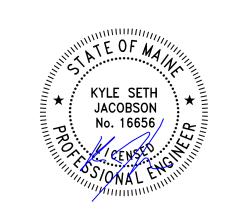DESIGNED BY:

DRAWN BY:

CHECKED BY:

DATE:

7/20/2022

FILE NAME:

1172-0002 DET01.dwg

PROJECT NAME:

LOT 22 LIBBY HILL BUSINESS PARK 12 TROIANO WAY GARDINER. MAINE


CLIENT:


GARDINER TRANSFER COMPANY, LLC PO BOX 3541 PORTLAND, MAINE

SHEET TITLE:


EROSION &
SEDIMENTATION
CONTROL NOTES
& DETAILS

SHEET NO:

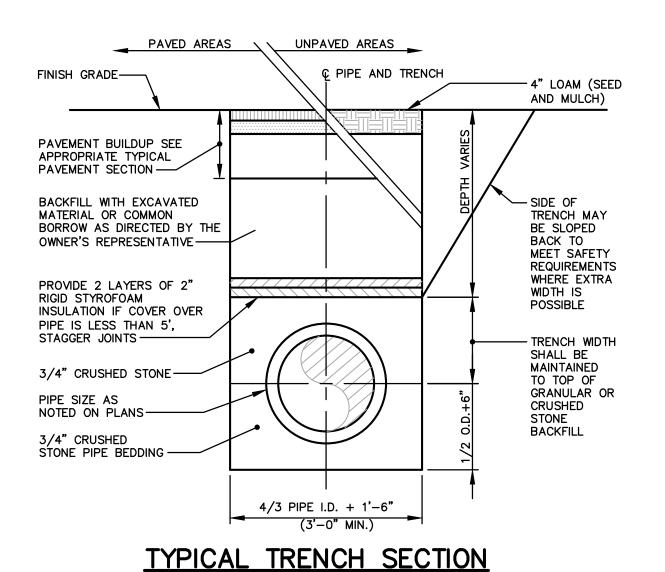

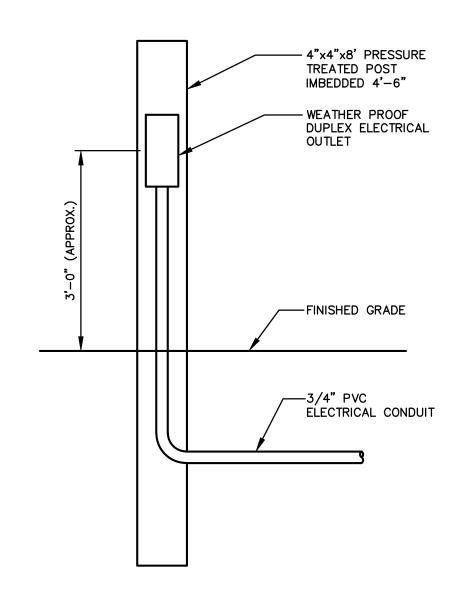


BLOCK HEATER OUTLET

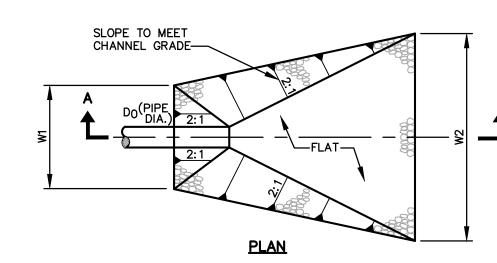

NOTE: FOR SINGLE PIPES, W1= 3D₀ FOR TWIN PIPES, W1= 2D₀ FOR EACH PIPE + THE CLEAR DISTANCE BETWEEN PIPES.

TYPE ID.	APRON DIM. (FEET)		D50 RIPRAP	
TIPE ID.	W2	L	SIZE (IN)	(IN)
6"	7	6	6	10
12"	12	10	6	12
15"	14	12	6	12
18"	16	14	6	12

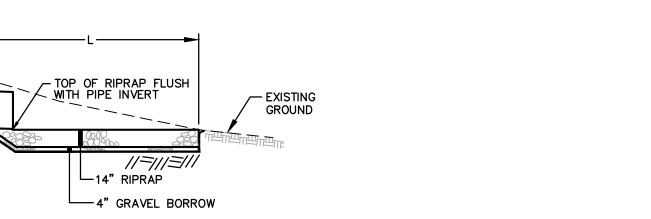

NOTES:

PIPE

PROPOSED

GEOTEXTILE FABRIC -


MIRAFI 180N NONWOVEN

STORM DRAIN -

- 1. RIPRAP SIZE D50 = 6"
- IN DEFINED CHANNELS, APRON SHALL EXTEND FULL WIDTH OF BOTTOM AND ONE FOOT ABOVE MAX. TAILWATER OR UP TO BANK FULL,, WHICHEVER IS LESS.

RIPRAP INLET/OUTLET PROTECTION

SECTION A-A

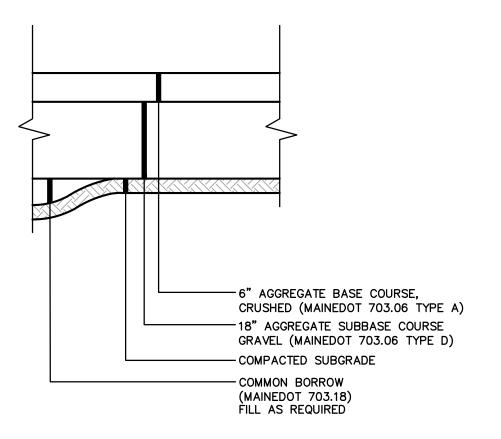

NOTES:

1. THE NON-ORGANIC ON-SITE SOILS MAY BE SUITABLE FOR REUSE AS COMMON BORROW IN GRAVEL STORAGE PAD AREA, PROVIDED THEY ARE AT A COMPACTABLE OF PLACEMENT.

2. ALL MATERIALS SHALL CONFORM TO MAINEDOT SPECIFICATIONS, LATEST REVISION. COMPACTION OF ALL MATERIALS TO BE IN ACCORDANCE WITH MAINEDOT SPECIFICATIONS.

GRAVEL BUILDUP NOT TO SCALE

." CABLE TV.:.\ 6" MIN. SEPARATION

12"

-COMMUNICATION CABLE USE 4" PVC (SCH. 40) CONDUIT FOR MAIN CABLES

AND 2" PVC (SCH. 40) CONDUIT FOR SERVICE FEEDS UNDER PAVED AREAS.


SECONDARY OR SERVICE CABLE USE 2"

(MIN.) DIA. SCH. 40 PVC ELECTRICAL

CONDUIT UNDER PAVED AREAS


PRIMARY ELECTRIC CABLE USE 4"
DIA. SCH. 40 PVC ELECTRICAL

CONDUIT UNDER PAVED AREAS

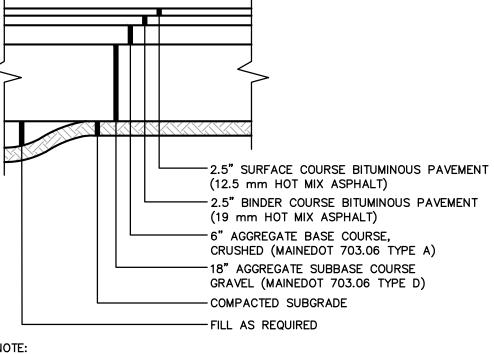


CONSTRUCTION REQUIREMENTS SHALL BE IN ACCORDANCE WITH SPECIAL PROVISIONS SECTION 401 AND 403, AS PER THE STATE OF MAINE, DEPARTMENT OF TRANSPORTATION "STANDARD SPECIFICATIONS FOR HIGHWAYS AND BRIDGES"


LATEST REVISION. PAVEMENT BUILDUP - HEAVY DUTY

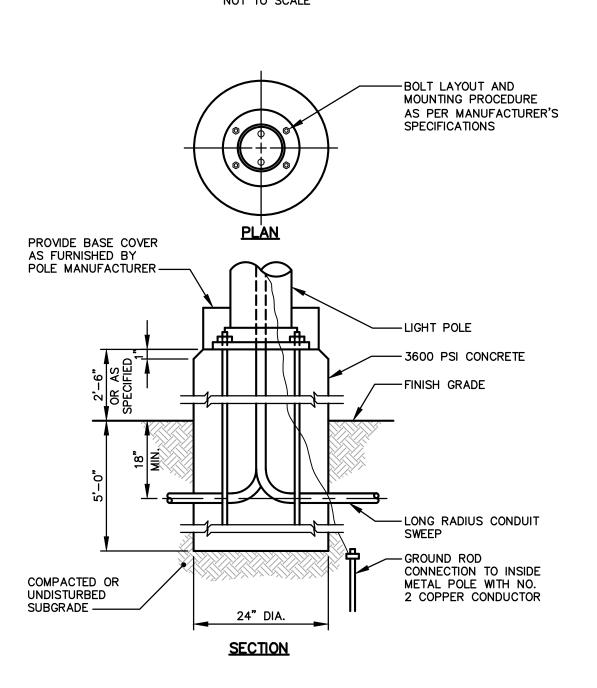

LIGHT POLE BASE

NOT TO SCALE

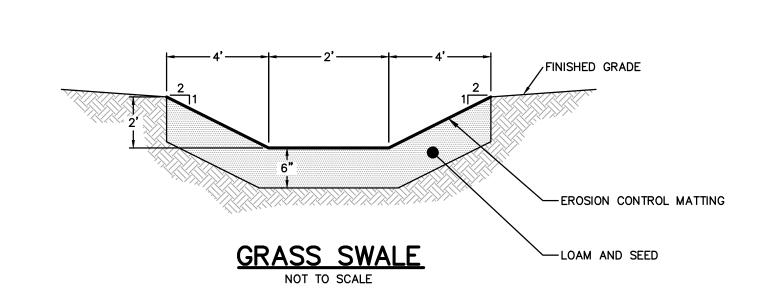

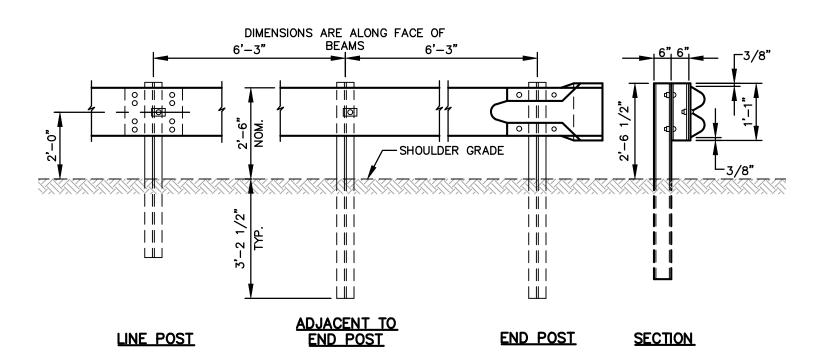

- 1. INTERMEDIATE POST SPACING SHALL BE 6'-3" UNLESS OTHERWISE SHOWN. 2. POST AND OFFSET BRACKETS SHALL BE 4"x 6" I-BEAM 8.5 OR 9.0 LBS. PER FOOT. LENGTH OF 5'-9" ATTACHED WITH 5/8" DIA. BOLTS WITH HEX NUTS.
- 3. ALL HOLES IN BEAM TO BE SHOP-PUNCHED PRIOR TO GALVANIZING.

 4. RAIL PANELS AND END SECTIONS TO BE 12 GAUGE STEEL.

 5. BACK-UP PLATE TO BE PLACED BEHIND RAIL ELEMENTS AT INTERMEDIATE
- STEEL POSTS (NON-SPLICE POSTS).


 6. ALL PARTS SHALL CONFORM TO CURRENT MAINE DEPARTMENT OF
- TRANSPORTATION STANDARD SPECIFICATIONS.

 7. WHEN GUARDRAIL IS CONSTRUCTED AT UP TO FOUR FEET FROM THE EDGE OF PAVEMENT, THE GUARDRAIL WILL BE SET FROM THE GRADE AT THE FACE OF
- 8. END SECTIONS TO BE IN ACCORDANCE WITH CURRENT MAINE DEPARTMENT OF TRANSPORTATION STANDARDS.

 9. GUARDRAIL SET ON A RADIUS OF 150 FEET OR LESS TO BE CIRCULAR.

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SCRIPTION

DESIGNED BY: DRAWN BY: PMG CHECKED BY: PJC DATE: 7/20/2022 FILE NAME: 1172-0002 DET01.dwg

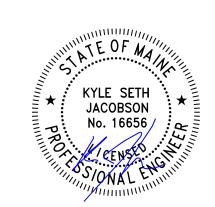PROJECT NAME:

LOT 22 LIBBY HILL BUSINESS PARK 12 TROIANO WAY GARDINER, MAINE

CLIENT:

GARDINER TRANSFER COMPANY, LLC PO BOX 3541 PORTLAND, MAINE

SHEET TITLE:

DETAILS

SHEET NO:

C-502

FINISH GRADE-

COMPACTED BACK FILL -

PLASTIC CABLE MARKER

CONTINUOUS IN TRENCH -

UNDERGROUND ELECTRICAL <u>& TELEPHONE CONDUIT</u>

 POLES: -5/16" STAINLESS STEEL STRAND END POLE (TYP.)— — CENTER POLE (TYP.) -1/4" STEEL STRAND SUPPLY AND INSTALL POLYESTER NETTING MATERIAL PER —POLYESTER NETTING MANUFACTURER'S RECOMMENDATIONS --CLASS II TIMBER UTILITY POLE 1/4" STEEL STRAND — -1/4" STEEL STRAND 1/4" STAINLESS STEEL ŚTRAND —1'−0" DIA. POLE (TYP.) -1'-6" DIA. BACKFILL WITH AGGREGATE BASE (TYP.) 6"-3/4"X66" GALVÁNIZED STEEL HELICAL DEADMAN (TYP.) 25'-0" **ELEVATION** <u>SECTION</u> LITTER FENCE

CONSTRUCTION NOTES

- A. POLES SHALL BE MINIMUM 44' CLASS II TIMBER UTILITY
- B. GUY LINES SHALL BE INSTALLED FOR ANY POLE WHERE
- THERE IS A CHANGE IN DIRECTION. C. POLES SHALL BE INSTALLED AT A MINIMUM DEPTH OF 14
- FEET AND BACKFILLED WITH AGGREGATE BASE.
- D. THE CONTRACTOR SHALL LAYOUT AND STAKE THE LOCATION OF ALL POLES AND GUY WIRE ANCHORS. THE OWNER OR THE OWNER'S REPRESENTATIVE SHALL APPROVE THE STAKED LOCATIONS PRIOR TO INSTALLATION OF THE POLES AND GUY LINES.

2. NETTING:

- A. NETTING SHALL BE 1 INCH MESH, POLYESTER ROPE BORDERED BARRIER NET.
- B. NETTING SHALL BE HIGH TENACITY POLYESTER WITH A MINIMUM MESH BREAKING STRENGTH OF 100 LBS. PER ASTM D-3787.
- C. NETTING SHALL BE LONG STITCH KNOT-LESS CONSTRUCTION.
- D. NETTING SHALL BE UV IMPREGNATED FIBER AND NOT DIPPED DYED OR BONDED.
- E. ATTACHMENT TWINE SHALL BE NO. 42 DIAMOND BRAIDBACK POLYESTER WITH A MINIMUM 325 LB. TENSILE
- STREGTH UV TREATED BLACK. F. PERIMETER BORDER ROPE AND HORIZONTAL ROPE SHALL BE 3/8 INCH DIAMETER BLACK POLYPROPYLENE COVER OVER PARALLEL CORE WITH A MINIMUM 2,500 LB. TENSILE
- G. THE ATTACHMENT TWINE SHALL CONTINUALLY ENCOMPASS THE NETTING COMPONET TO THE ROPE (SPRIAL WOUND) AND BE TIED OFF THE PERIMETER ROPE USING A CLOVE AND ONE HALF HITCH KNOT \pm 12 INCHES ON CENTER.
- H. NETTING SHALL BE ATTACHED TO ALL LINES (I.E. TOP, WIND, BOTTOM) USING SNAP HOOKS WITH A MAXIMUM SPACING OF 24 INCHES HORIZONTALLY AND VERTICALLY.
- I. NETTING MANUFACTURE SHALL WARRANTY THE NET FOR A MINIMUM 10 YEAR PERIOD.
- CONSTRUCTION:
 - THE CONTRACTOR WILL MEASURE AND PROVIDE ALL DIMENSIONS, ELEVATIONS AND CONDITIONS AT THE JOB SITE PRIOR TO CONSTRUCTION AND THE SUBMISSION OF SHOP DRAWINGS, AND WILL NOTIFY THE ENGINEER IMMEDIATELY OF ANY DISCREPANCIES.
- B. PROVIDE TEMPORARY BRACING AND SHORING, AS REQUIRED, TO ENSURE POLES REMAIN PLUMB DURING
- C. PROVIDE ANY NECESSARY HARDWARE TO INSTALL NETTING IN CONFORMANCE WITH MANUFACTURER'S RECOMMENDATIONS.
- D. ALL HARDWARE SHALL BE HOT DIPPED GALVANIZED.

TOP OF WALL EL.=SEE PLAN VIEW -EXCAVATOR PLATFORM (SEE GRAVEL BUILDUP DETAIL) RETAINING WALL -RETAINING WALL - MIRAFI 180N STABILIZATION FABRIC *BACKFILL WITH C&D DEBRIS TRANSFER PAD STRUCTURAL FILL TRAILER BAY /─3/4" STEEL CONT. ISOLATION PLATE CAST JOINT, SEE DETAILS INTO SLAB TOP OF SLAB EL. (SEE PLAN VIEW) CONCRETE SLAB, (TYPICAL SLAB DETAIL) (TYPICAL SLAB DETAIL) ~ ROUGHEN AGGREGATE SUBBASE AGGREGATE SUBBASE SURFACE -CONT. 6" DIA. PERFORATED UNDERDRAIN PIPE BEDDED IN 8" OF 3/4" CRUSHED STONE WRAPPED IN MIRAFI 140N GEOTEXTILE FILTER


> RETAINING WALL/FOOTING CONCRETE NOTES:
>
> 1. CONCRETE F'c=4000psi, 6% ENTRAINED AIR. 2. REINFORCING GRADE 60, NEW DEFORMED BARS. MAXIMUM W/C=0.48. 4. SEE SITE PLAN FOR LAYOUT REQUIRED. 5. PROVIDE WALL DESIGN BY MAINE LICENSED STRUCTURAL ENGINEER.

TYPICAL CONCRETE RETAINING WALL SECTION A-A'

FABRIC. (PERFORATIONS ORIENTATED

DOWNWARD)


-SEE TYPICAL SLAB CONTINUOUS SIKAFLEX SEALANT OVER CONT. BACKER ROD-REINF. CONCRETE SLAB, [→](SEE TYP. SLAB DETAIL) CONT. INSOLATION JOINT FILLER UP TO BACKER ROD— -2-#4 CONT. @ BOTTOM FACE OF CONCRETE WALL TYPICAL SLAB-EDGE <u>DETAIL</u> **DETAIL** NOT TO SCALE NOT TO SCALE

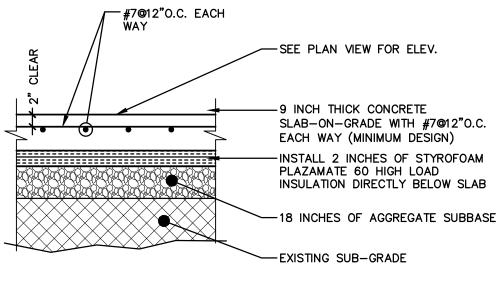

- ENTRAINED AIR, LIGHT BROOM FINISH.

 2. PROVIDE CHLORIDE PROTECTING SEALANT EQUAL TO SIKAGUARD 701W ON ALL SLABS.
- 2. REINFORCING STEEL ASTM A615, GRADE 60, NEW DEFORMED
- 3. MAXIMUM W/C=0.40.
- EACH DIRECTION, SPLICES ARE NOT ALLOWED-NO EXCEPTION. 5. SEE SITE PLAN.
- 6. MINIMUM SLAB REQUIREMENTS. PROVIDE DESIGN BY MAINE LICENSED STRUCTURAL ENGINEER.

NOT TO SCALE

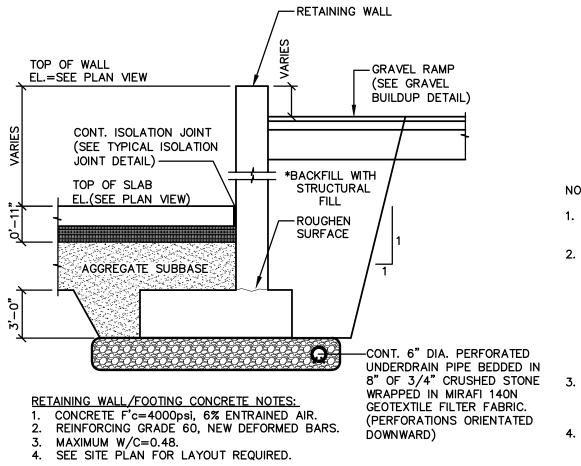

TYPICAL CONCRETE RETAINING WALL SECTION B-B'

NOTES:

- 1. CONTRACTOR TO PROVIDE STRUCTURAL DESIGN OF RETAINING WALLS AND SLABS STAMPED BY A MAINE LICENSED ENGINEER.
- 2. DESIGN LOADS: EXCAVATOR PLATFORM, CONCRETE PADS AND WALLS TO BE DESIGNED TO HANDLE THE FOLLOWING LOADS: • 60,000 LB. TRACK-MOUNT EXCAVATOR • 50,000 LB. RUBBER TIRE FRONT END LOADER • 300,000 LB. MATERIAL ON C & D DEBRIS TRANSFER PAD

DEBRIS TRANSFER PAD

PROVIDE STEEL PLATE FULL LENGTH OF NORTH WALL AT C&D DEBRIS TRANSFER PAD AND 20 FEET OF WEST WALL AT C&D DEBRIS TRANSFER PAD.

•100,000 LB. TRACTOR TRAILER ON TRAILER BAY AND C&D

PROVIDE STAIRWAY EQUAL TO FIXED ALUMINUM INDUSTRIAL STAIR BY PRECISION LADDERS, LLC. MINIMUM STAIR WIDTH SHALL BE 22 INCHES AND 45 DEGREE MAXIMUM PITCH.

SHEET NO:

C-503

846 Main St., Westbrook, Maine 04092

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KYLE SETH JACOBSON

No. 16656 /

PMG

PJC

7/20/2022

1172-0002 DET01.dwg

LOT 22

LIBBY HILL BUSINESS PARK

12 TROIANO WAY

GARDINER, MAINE

GARDINER TRANSFER

COMPANY, LLC PO BOX 3541

PORTLAND, MAINE

DETAILS

REV. DATE REVISION DESCRIPTION

DESIGNED BY:

CHECKED BY:

PROJECT NAME:

DRAWN BY:

FILE NAME:

DATE:

CLIENT:


SHEET TITLE:

TYPICAL ISOLATION JOINT

SLAB NOTES:
1. CONCRETE F'c=4500psi, 1 1/2" AGGREGATE, 4% TO 6%

4. #7 REINFORCING BARS TO BE ONE-PIECE AND CONTINUOUS

TYPICAL SLAB

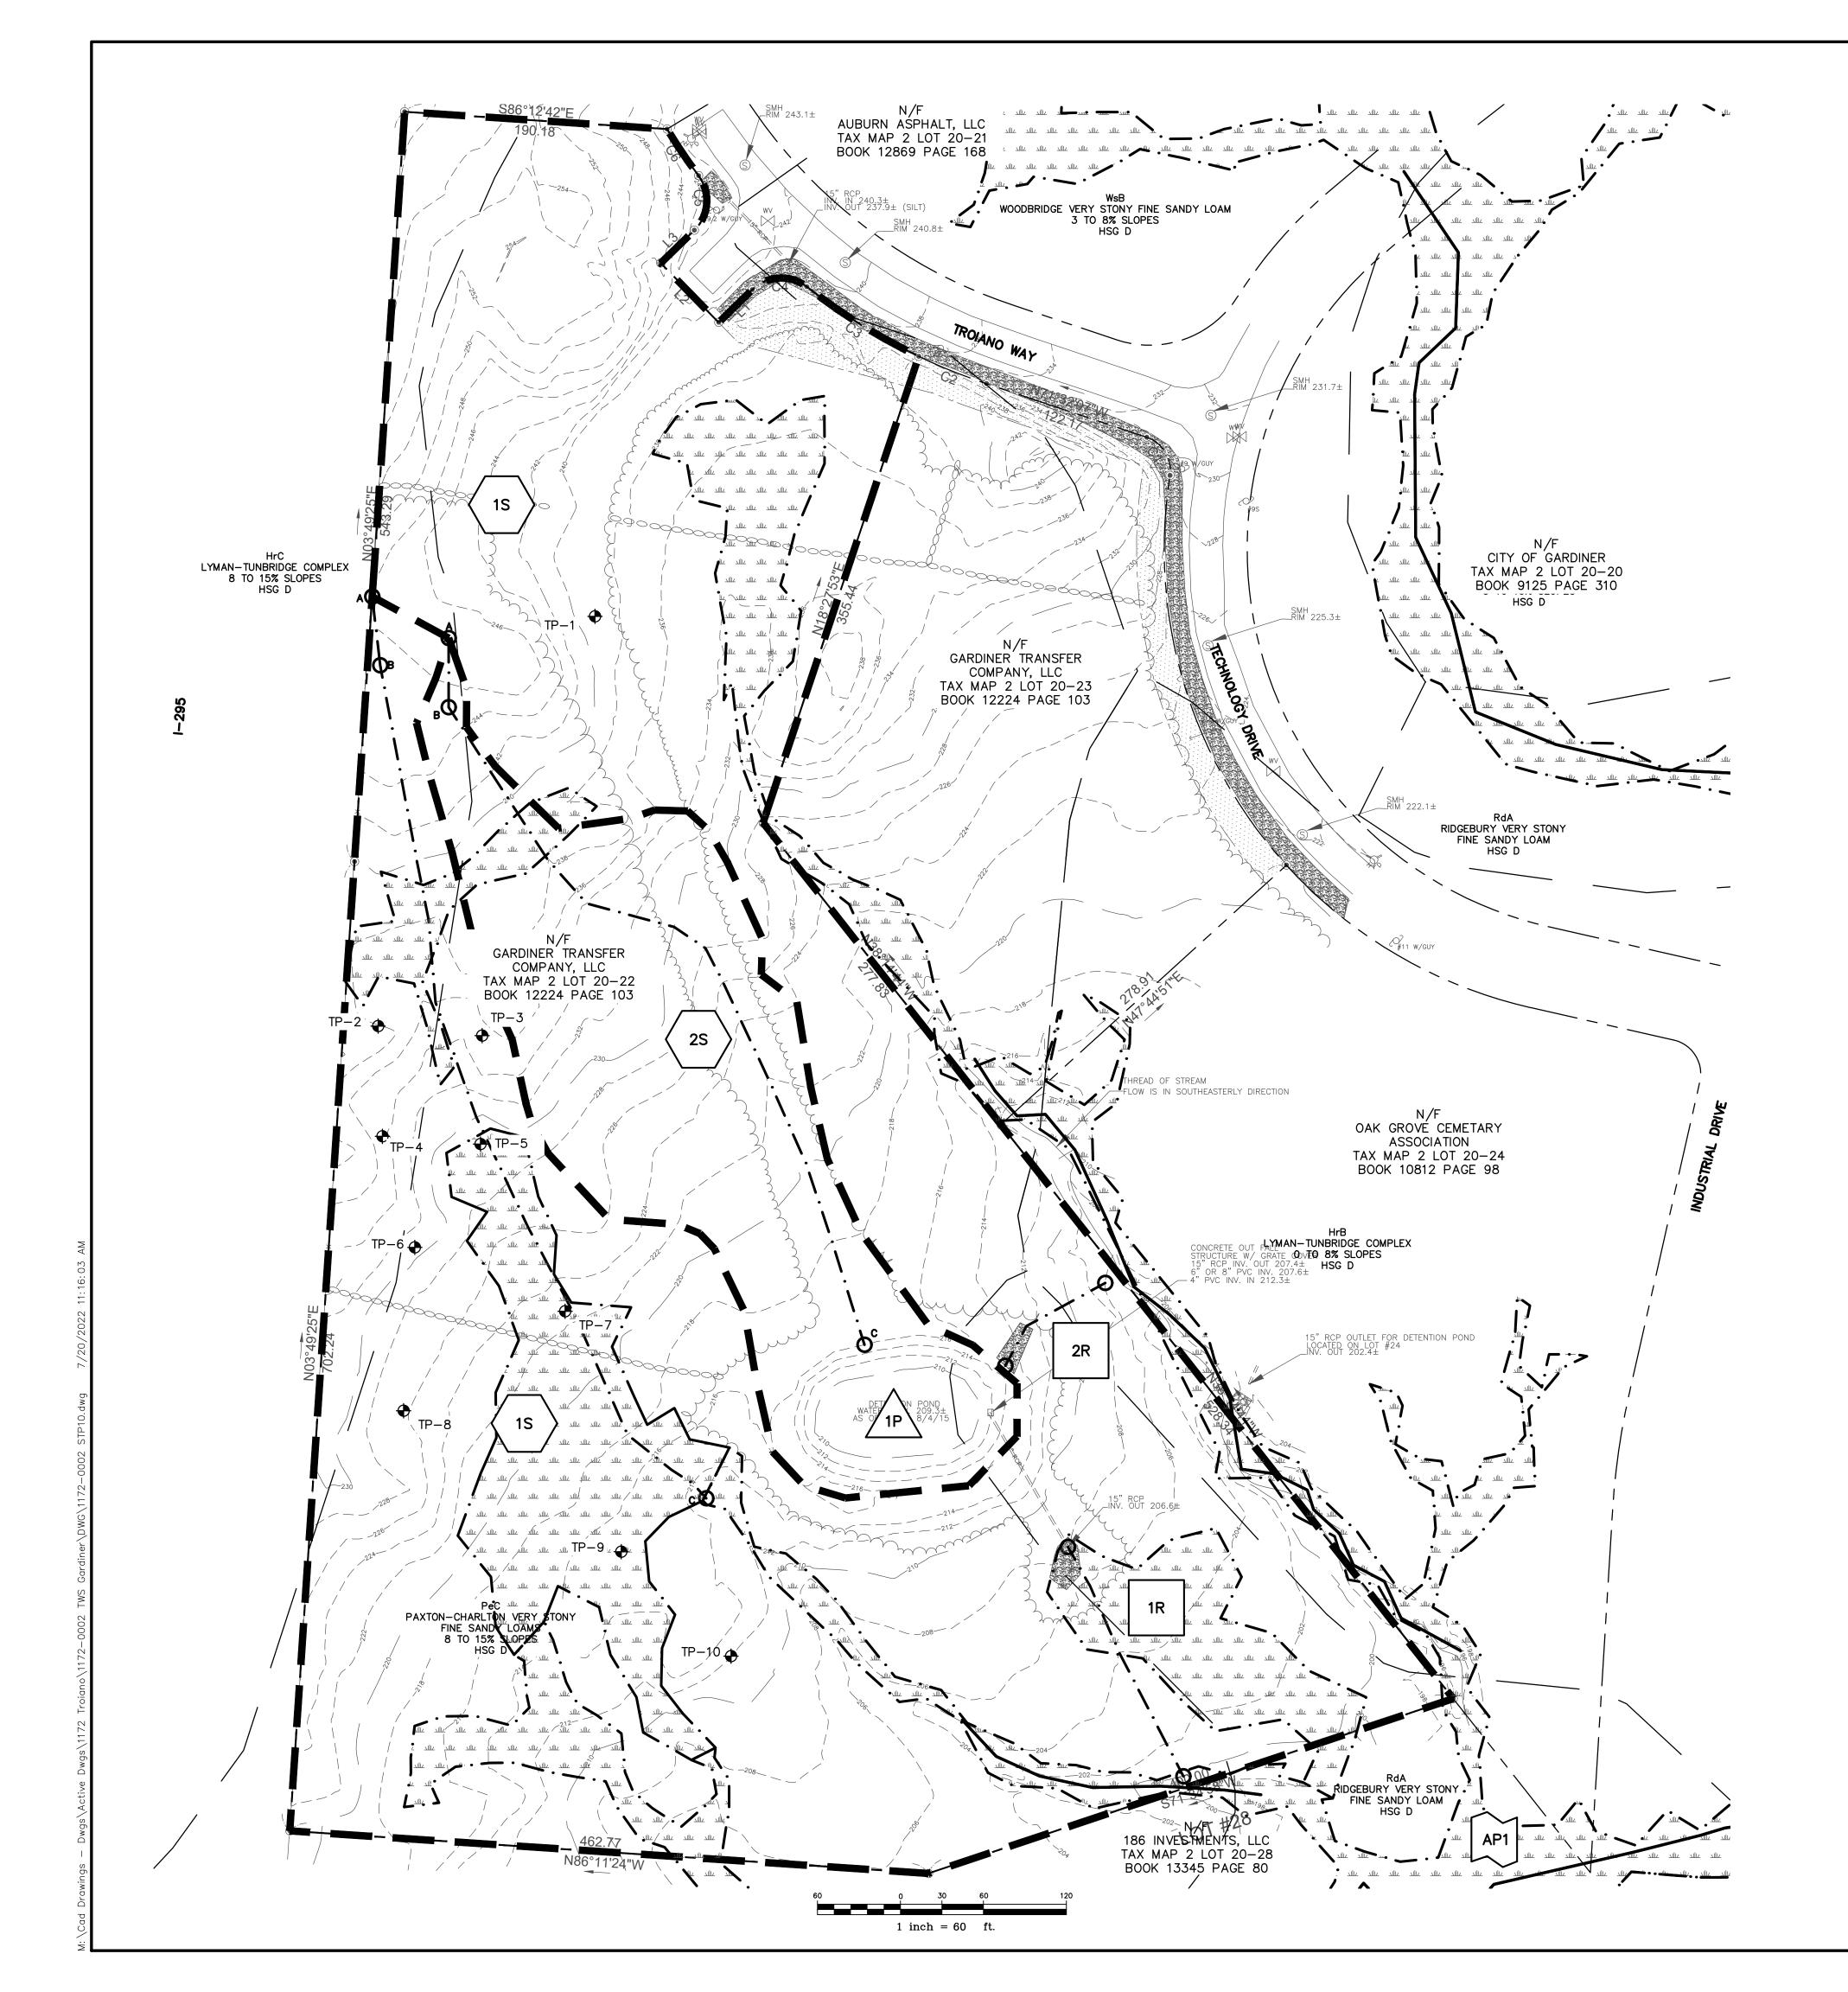

- THE PURPOSE OF THIS PLAN IS TO DEPICT THE EXISTING CONDITIONS FOR TAX MAP 2 LOT 20-22 IN GARDINER, MAINE. THE TOTAL AREA OF THE SUBJECT PARCEL IS 13.49± ACRES.
- THE OWNER OF RECORD FOR TAX MAP 2 LOT 22 IN GARDINER, MAINE IS GARDINER TRANSFER COMPANY, LLC, C/O TROIANO WASTE SERVICES, INC, PO BOX 3541, PORTLAND, MAINE 04104 RECORDED IN THE KENNEBEC COUNTY REGISTRY OF DEEDS BOOK 12224 PAGE 103.
- 3. PROPERTY BOUNDARIES ARE BASED ON A PLAN ENTITLED "LIBBY HILL BUSINESS PARK PHASE 2, WEEKS ROAD AND ENTERPRISE AVENUE, GARDENER, MAINE" PREPARED BY MAINE COAST SURVEYING AND RECORDED IN THE KENNEBEC COUNTY REGISTRY OF DEEDS PLAN BOOK 2007, PAGE 137 AND 138.
- 4. TOPOGRAPHIC INFORMATION IS BASED ON A PLAN ENTITLED "EXISTING CONDITIONS LOTS 22 & 23 LIBBY HILL BUSINESS PARK" BY BOUNDARY ENGINEERING SURVEY TECHNOLOGY, DATED AUGUST 7, 2015. TOPOGRAPHIC ELEVATIONS ARE BASED ON TEMPORARY BENCHMARK A FROM RECORD DRAWING - MANHOLE NO. 69 RIM ELEVATION 264.80. HORIZONTAL DATA BASED ON NAD83 MAINE STATE PLANE WEST DATUM.
- 5. WETLAND BOUNDARIES OBTAINED FROM A FIELD SURVEY PERFORMED BY MICHAEL JOHNSON OF WOODLOT ALTERNATIVES, INC ON AUGUST 6, 2004 AND FIELD VERIFIED BY TOM TETREAU, PWS OF STANTEC CONSULTING SERVICES, INC ON DECEMBER 20, 2019.
- 6. SOIL TYPES FOR THE SITE WERE OBTAINED FROM THE USDA NATURAL RESOURCES CONSERVATION SERVICE WEB SOIL SURVEY MEDIUM INTENSITY SOILS MAPPING. THE WATERSHED IS COMPOSED OF PAXTON-CHARLTON VERY STONY FINE SANDY LOAM (PeC) - HYDROLOGIC SOIL GROUP (HSG) D, LYMAN-TUNBRIDGE COMPLEX (HrB'& HrC) — HSG D, WOODBRIDGE VERY STONY FINE SANDY LOAM (WsB) — HSG D, AND RIDGEBURY VERY STONY FINE SANDY LOAM (RdA) - HSG D.
- 7. PRE-DEVELOPMENT SUBCATCHMENTS:

1S AREA: 494,880 SF

Tc: 19.9 MINUTES

A-B SF L=50' S=0.0400 B-C SCF L=663' S=0.0483

2S AREA: 252,274 SF CN=77 Tc: 21.4 MINUTES

A-B SF L=50' S=0.0200

B-C SCF L=576' S=0.0512

A-B CF L=185' S=0.0324


A-B CF L=97.5' S=0.0821

<u>LEGEND</u>

	11101 =1111 = =111= / 1101
	ADJACENT PROPERTY I
	SETBACKS
• •	MONUMENTS
710	CONTOURS
	EDGE OF GRAVEL
	EDGE OF PAVEMENT
- · - · - · -	EDGE OF WETLAND
<u>7 7</u>	WETLAND SYMBOL
	CURB
	PAVEMENT STRIPING
	BUILDINGS
· · · * * *	TREELINE/TREES
· 000000000000000000000000000000000000	STONEWALL
- -	SIGNS
•	BOLLARDS
Ø	UTILITY POLE
15	SUBCATCHMENT
AP1	ANALYSIS POINT
1P	POND
⋒ · ─ ®	TC FLOWPATH
	SUBCATCHMENT BOUND
	NRCS SOIL BOUNDAR



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REV.	DATE	REVISION DESCRIPTION			

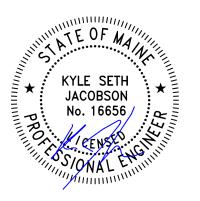DESIGNED BY: DRAWN BY: CHECKED BY: DATE: FILE NAME: 1172-0002 STP10.dwg

PROJECT NAME:


LOT 22 LIBBY HILL BUSINESS PARK 12 TROIANO WAY GARDINER, MAINE

GARDINER TRANSFER COMPANY, LLC PO BOX 3541 PORTLAND, MAINE

SHEET TITLE:

PRE-DEVELOPMENT DRAINAGE **PLAN**

SHEET NO:

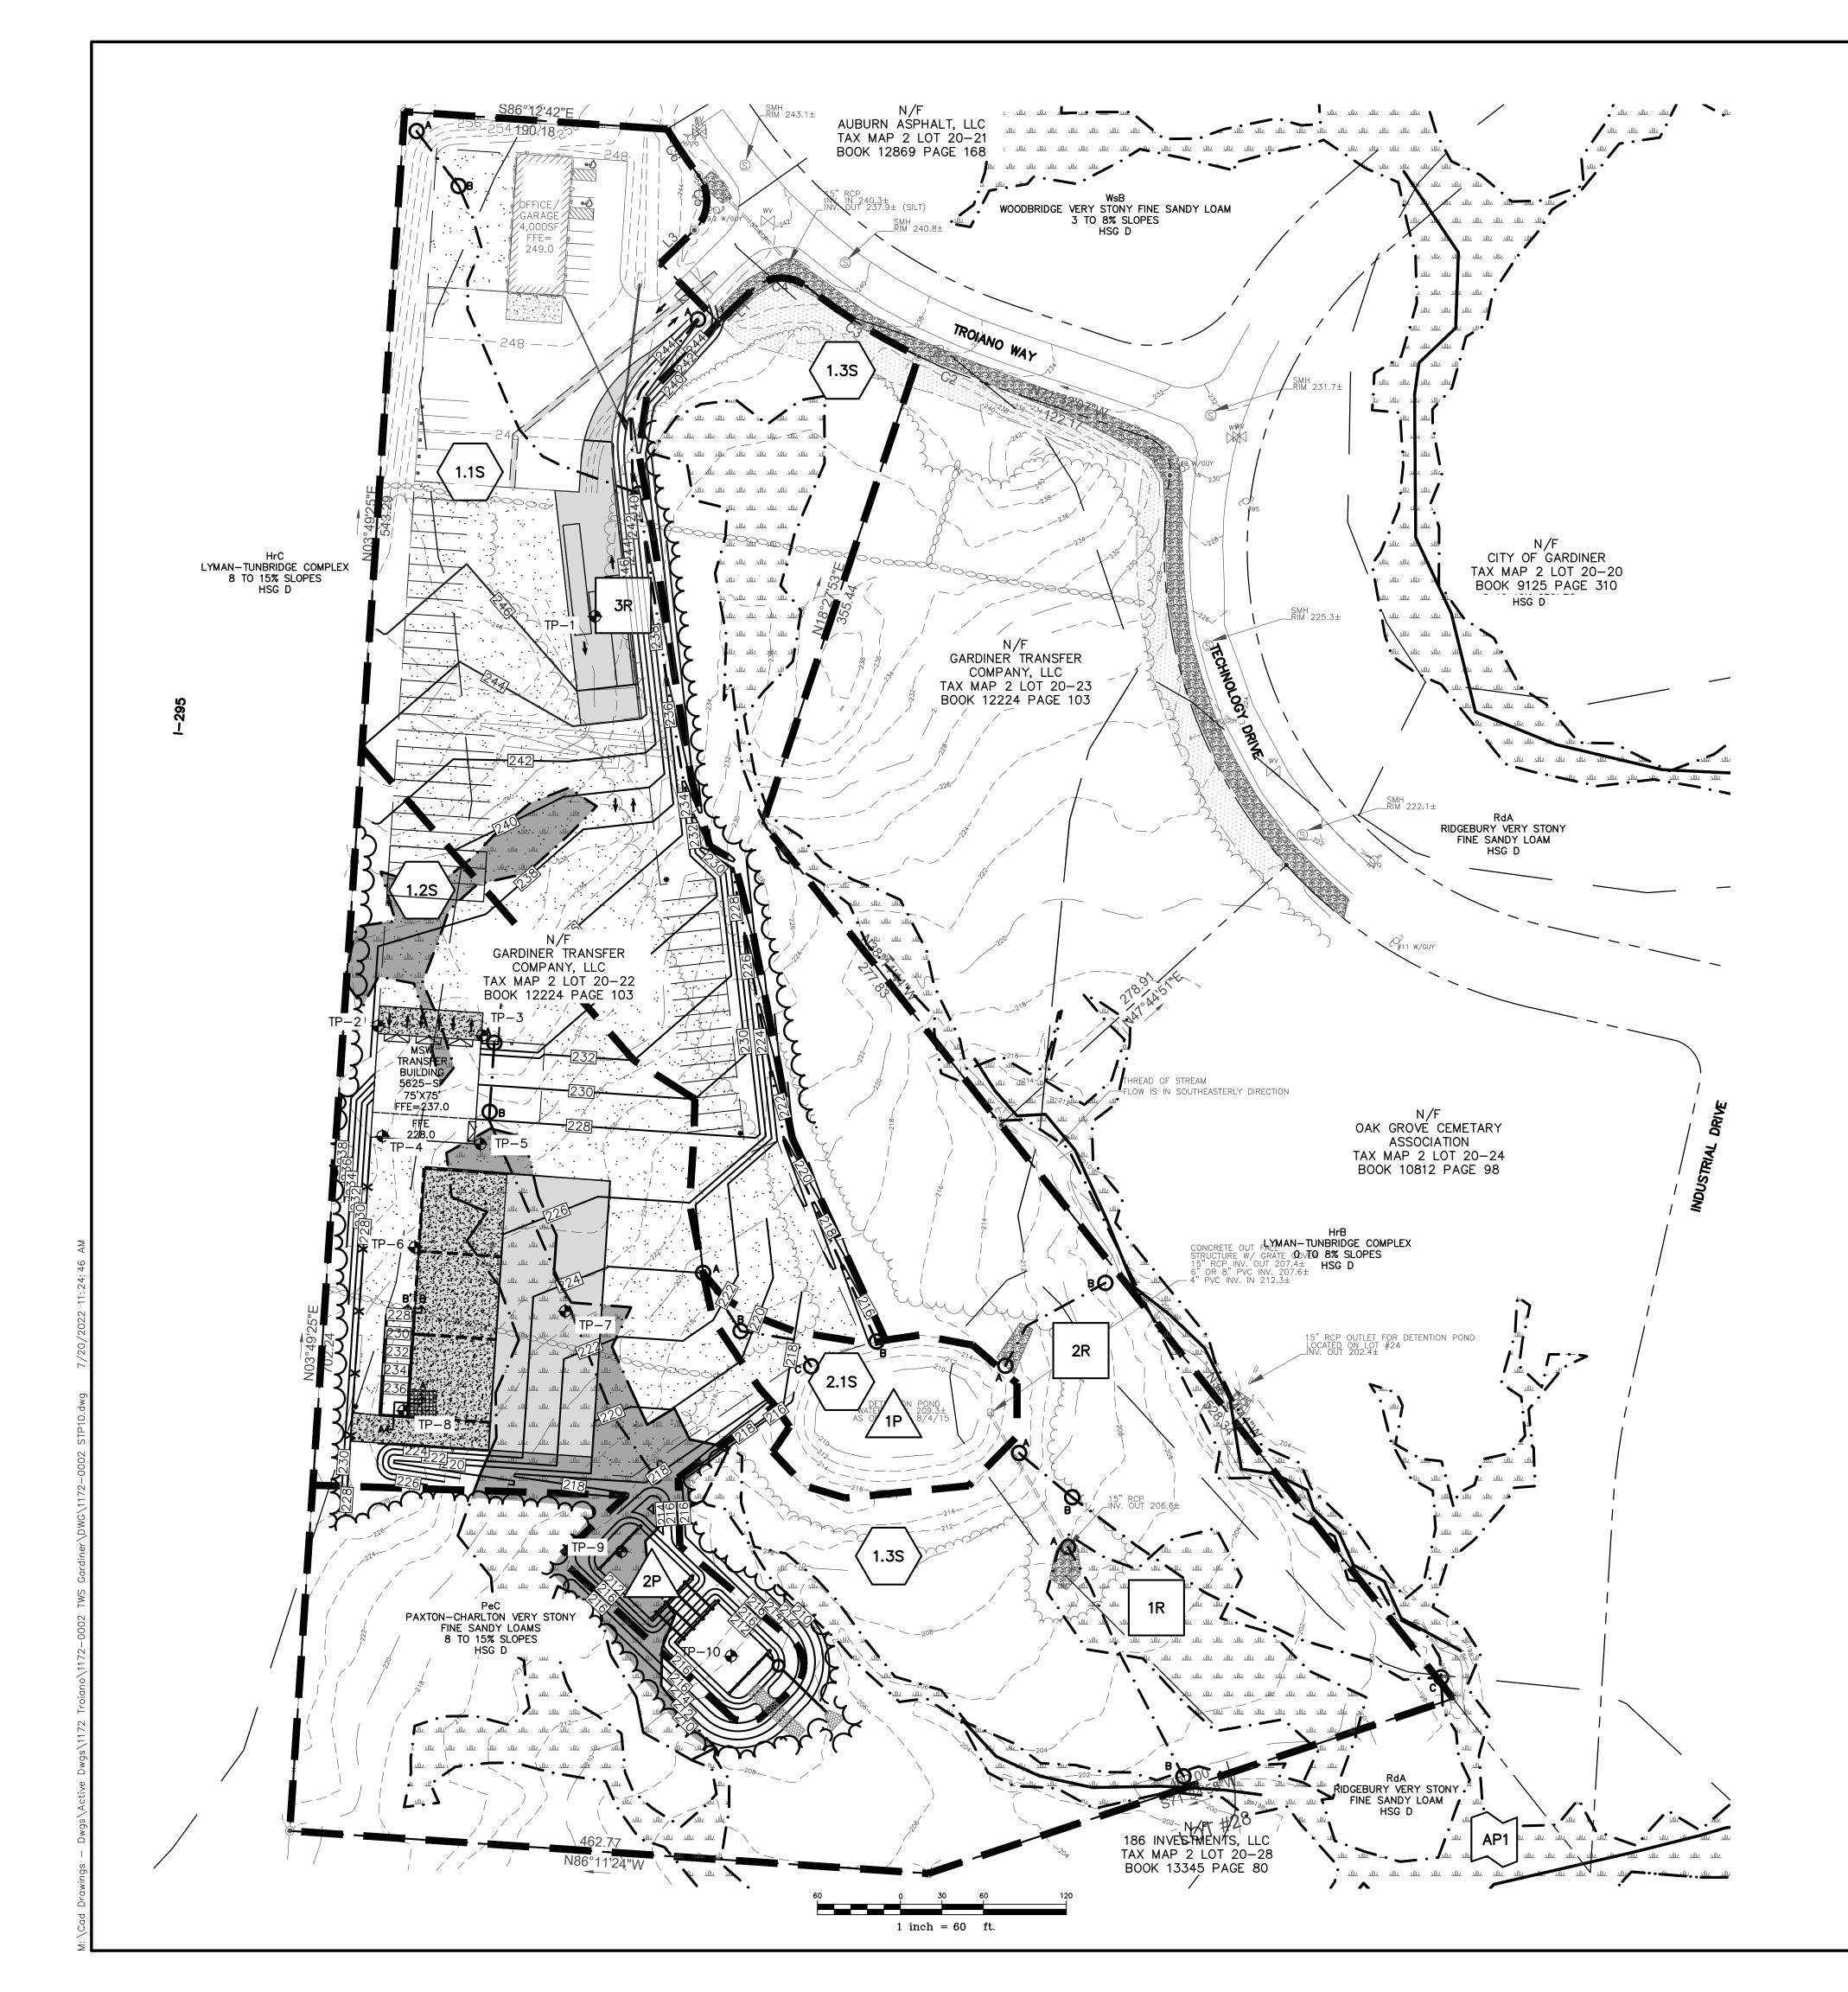


NOTES

- THE PURPOSE OF THIS PLAN IS TO DEPICT THE PROPOSED CONDITIONS FOR TAX MAP 2 LOT 20-22 IN GARDINER, MAINE. THE TOTAL AREA OF THE SUBJECT PARCEL IS 13.49± ACRES.
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- 6. SOIL TYPES FOR THE SITE WERE OBTAINED FROM THE USDA NATURAL RESOURCES CONSERVATION SERVICE WEB SOIL SURVEY MEDIUM INTENSITY SOILS MAPPING. THE WATERSHED IS COMPOSED OF PAXTON—CHARLTON VERY STONY FINE SANDY LOAM (PeC) HYDROLOGIC SOIL GROUP (HSG) D, LYMAN—TUNBRIDGE COMPLEX (HrB & HrC) HSG D, WOODBRIDGE VERY STONY FINE SANDY LOAM (WsB) HSG D, AND RIDGEBURY VERY STONY FINE SANDY LOAM (RdA) HSG D.
- 7. POST-DEVELOPMENT SUBCATCHMENTS:


1.1S AREA: 151,367 SF CN=98 Tc: 6.0 MINUTES A-B SF L=50' S=0.1700 B-C SCF L=289' S=0.0398 1.2S AREA: 122,621 SF CN=98 Tc: 6.0 MINUTES A-B SF L=50' S=0.1600 B-C SCF L=291' S=0.0344 1.3S AREA: 41,380 SF Tc: 7.5 MINUTES A-B SF L=50' S=0.1200 B-C SCF L=291' S=0.0429 2.1S AREA: 83,556 SF CN=98 Tc: 6.0 MINUTES A-B SF L=50' S=0.0600 B-C SCF L=62' S=0.0806 A-B CF L=185' S=0.0324 A-B CF L=97.5' S=0.0821 A-B CF L=790' S=0.0354

LEGEND

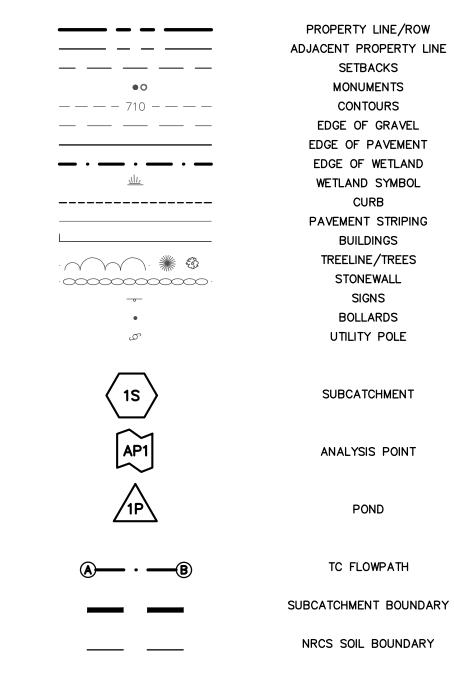



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REV.	DATE	REVISION DESCRIPTION

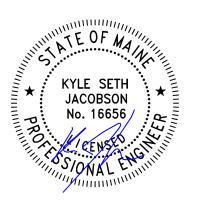DESIGNED BY: KSJ

DRAWN BY: PMG

CHECKED BY: PJC

DATE: 7/20/2022

FILE NAME: 1172-0002 STP10.dwg

PROJECT NAME:

LOT 22 LIBBY HILL BUSINESS PARK 12 TROIANO WAY GARDINER, MAINE

CLIENT:

GARDINER TRANSFER COMPANY, LLC PO BOX 3541 PORTLAND, MAINE

SHEET TITLE:

POSTDEVELOPMENT
DRAINAGE
PLAN

SHEET NO:

FIRST RIGHT ROAD 0.0 0.0 0.0 0.0 0.0 0.0 0.1 0.3 0.8 0.7 0.6 0.6 0.5 0.3 0.2 0.1 0.1 0.0 $0.0 \ 0.0$ 0.1 0.1 0.2 0.2 0.2 0.3 0.3 0.4 0.5 0.5 0.4 0.7 0.7 0.5 0.4 0.3 0.2 0.2 0.2 0.3 0.4 0.5 0.6 0.7 0.7 0.9 0.7 0.7 0.9 0.7 0.0 $0.1 \ 0.1 \ 0.1 \ 0.2 \ 0.3 \ 0.4 \ 0.5 \ 0.6 \ 0.7 \ 1.6 \ 1.6 \ 1.4 \ 1.4 \ 1.3 \ 1.2 \ 0.9 \ 0.7 \ 0.6 \ 0.5 \ 0.4 \ 0.3 \ 0.3 \ 0.3 \ 0.3 \ 0.3 \ 0.3 \ 0.3 \ 0.5 \ 0.6 \ 0.5 \ 0.4 \ 0.2 \ 0.0$ 0.0 0.0 0.0 0.0 0.0 0.0 0.0 0.0 0.0 0.0 0.0 0.0 0.0 0.0 0.0 0.0 0.0 FFE=237.0 b.3 b.5 b.6 b.5 b/3 b.2 b.1 b.1 b.1 b.1 b.2 b/2 b.3 b.5 b.6 b.7 b.9 1.1 b/6 b.1 b.1 b.1 b.0 b.0 b.0 b.0 b.0 b.0 b.0 0.0 0.0 0.0 0.0 0.0 0.0 0.0 0.0 0.0 0.0 0.0 0.0 0.0 0.0 dd 0.0 0.0 H 0.05.0 5.0 5.0 5.0 5.0 5.1 5.2 5.2 5.0

NOTES:

1) EXACT MOUNTING DETAILS TO BE DETERMINED AT JOBSITE BY OTHERS.

2) CALCULATIONS MAY or MAY NOT SHOW THE EFFECT OF SHADOWING CAUSED BY BUILDINGS AND OBJECTS WITHIN THE CALCULATED SPACE OR IN THE SITE AREA.

3) READINGS SHOWN ARE INITIAL HORIZONTAL FOOTCANDLES ON A FLAT SITE WITHOUT REFLECTIONS OR OBSTRUCTIONS UNLESS OTHERWISE INDICATED.
4) THIS CALCULATION IS BASED ON LIMITED INFORMATION SUPPLIED BY OTHERS TO

SWANEY LIGHTING ASSOCIATES AND STANDARD ASSUMPTIONS OF THE SPACE AND/OR SITE.

5) CONFORMANCE TO CODES AND OTHER LOCAL REQUIREMENTS AS DETERMINED BY THE AHJ
ARE THE RESPONSIBILITY OF THE OWNER AND/OR THE OWNER'S REPRESENTATIVE.

6) THIS LAYOUT DRAWING MUST BE COORDINATED WITH THE SITE LOCATION FOR

CORRECT FIXTURE ORIENTATION.

7) DOCUMENTS PRINTED OR PLOTTED FROM ELECTRONIC FILES MAY APPEAR AT OTHER THAN THE DESIRED OR ASSUMED GRAPHIC SCALES. IT IS THE RESPONSIBILITY OF THE RECIPIENT TO VERIFY THAT THE PRINTED OR PLOTTED-TO-SCALE DRAWING IS PRINTED TO SCALE.

Calculation Summary

Label Avg Max Min Avg/Min Max/Min

SITE 0.13 1.9 0.0 N.A. N.A.

Luminaire Schedule (note fixture cataloge numbers are not complete)							
Type	Qty	Lum. Lumens	LLF	Lum. Watts	Description		
SA	3	7908	0.900	81	VP-S-36L-80-3K7-4W		
W1	6	3971	0.900	44	LNC2-18L-3K-070-4		
SB	2	8100	0.900	81	VP-S-36L-80-3K7-4		

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GARDINER, ME

SITE LIGHTING LAYOUT


SWANEY LIGHTING ASSOCIATES, INC


TABLE BY AND THE EXCLUSIVE FROM THE THE DYNAME THE MILL BE TREATED AS TABLED STANCE CONSTITUTES AN AGREEMENT THAT THE DRAWING WILL BE TREATED AS TIAL. THIS DRAWING IS TO BE USED FOR NO PURPOSE OTHER THAN AS DETAILED TON CONCERNING THE OPERATION OF UNITS INDICATED. THIS DRAWING IS TO BE SSLY AUTHORIZED BY SWANEY LIGHTING ASSOCIATES.


HE INTENT OF THIS LIGHTING LAYOUT IS TO SUGGEST THE BEST UTILIZATION NG FIXTURES INCLUDED IN THIS DRAWING. IT IS PROVIDED USING FIXTURE PHOTOMETRIC D BY THE MANUFACTURER. ANY VARIATION IN FIXTURE PERFORMANCE FROM AND A LITHEOGRAPH OF THE MANUFACTURER. IT'S USE


PLAN VIEW

I-295

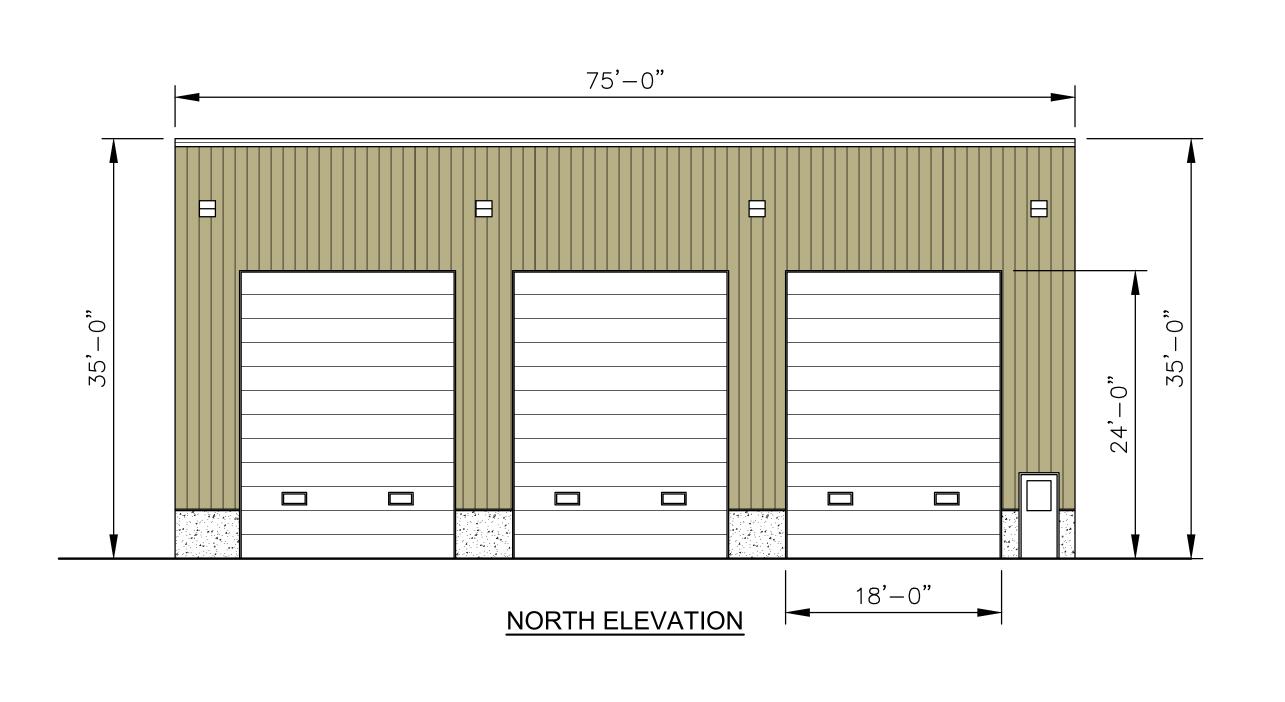

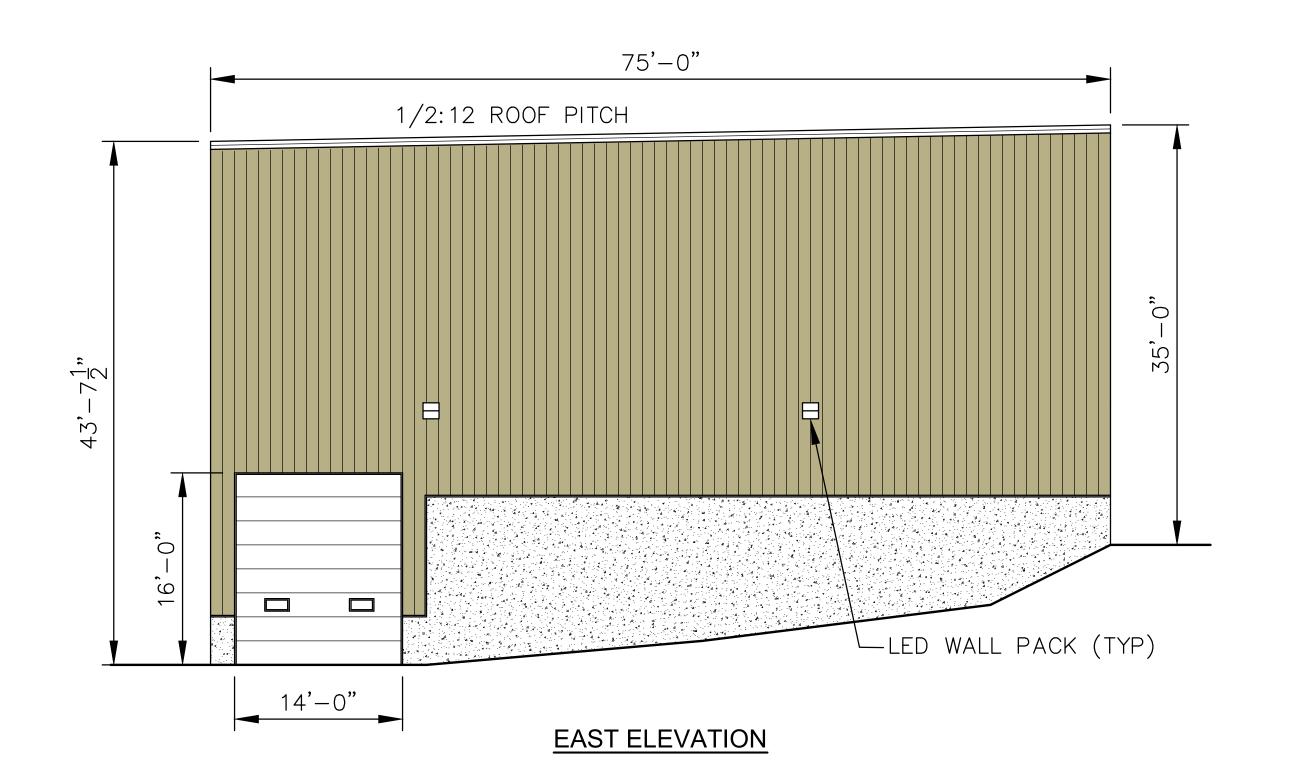

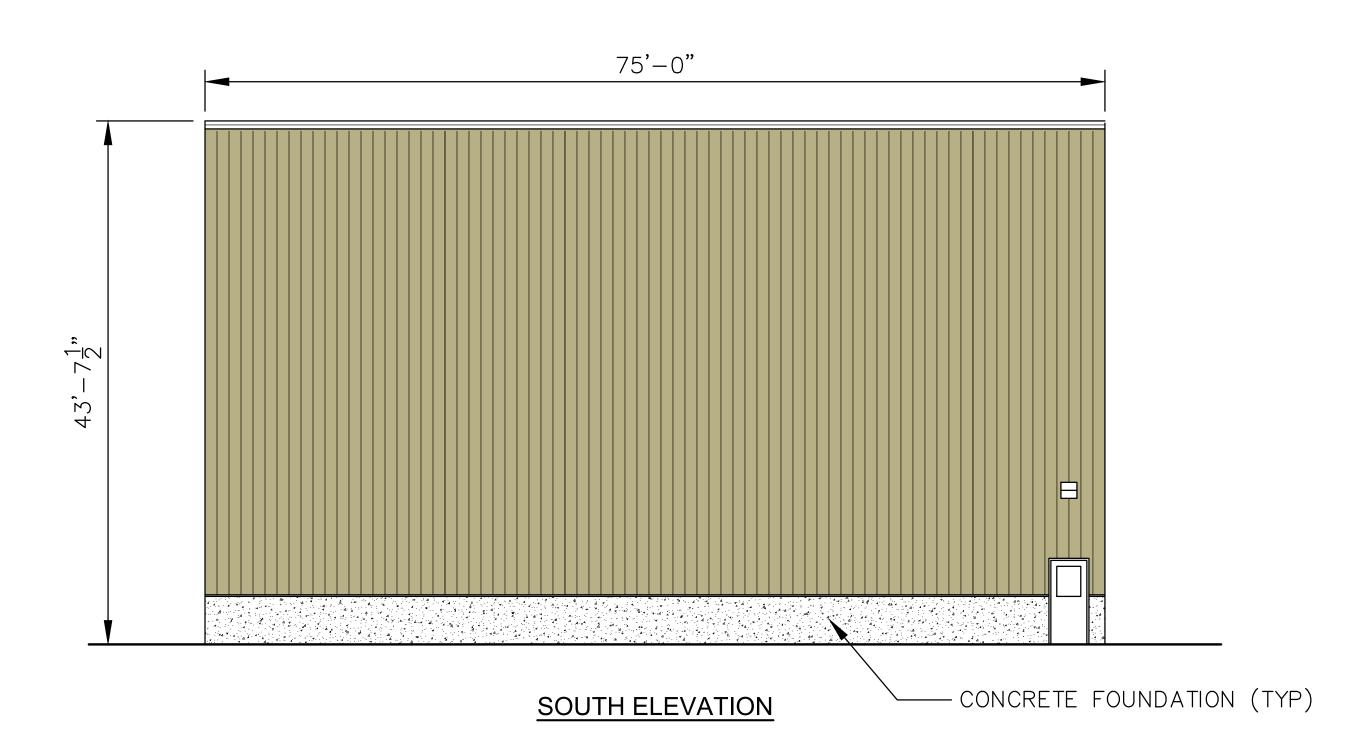

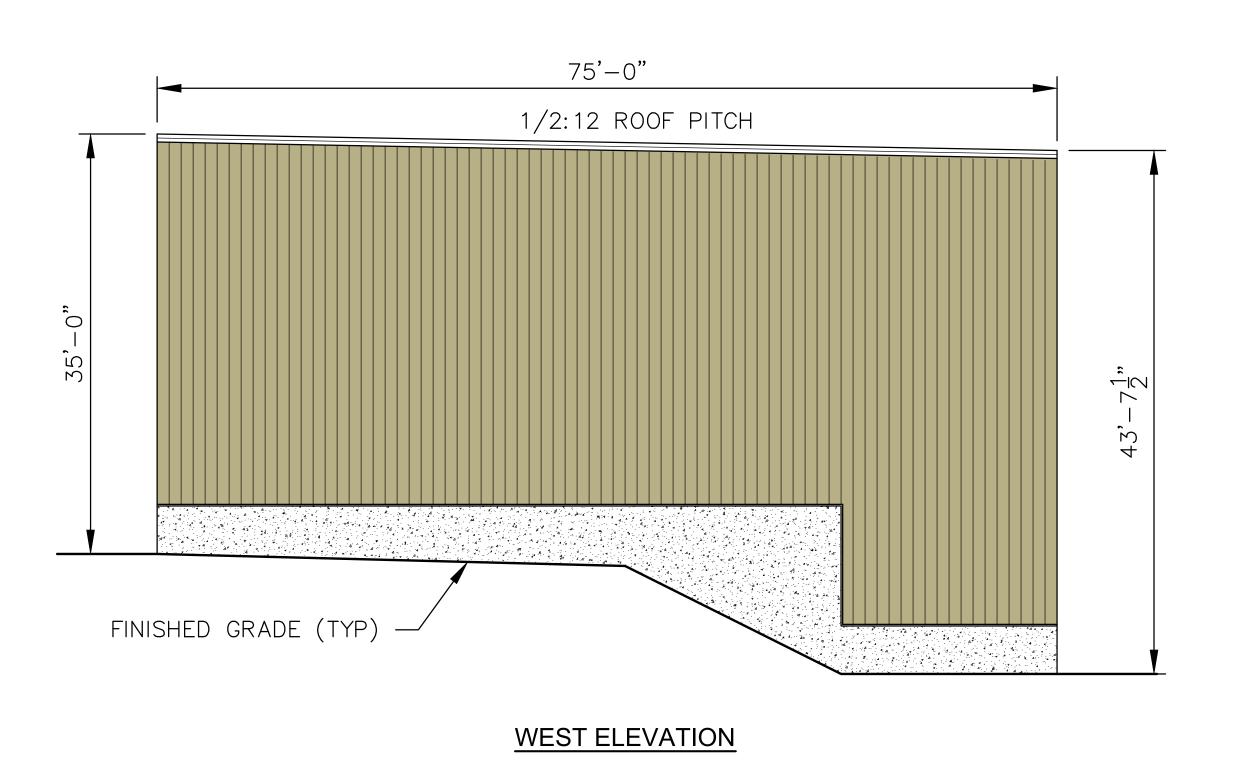



DRAFT

DATE	REVISION DESCRIPTION			
	DATE			

DESIGNED BY:

DRAWN BY:

CHECKED BY:

DATE:

FILE NAME:

KSJ

PMG

PMG

PJC

7/20/2022

FILE NAME:

1172-0002 ARC01.dwg

PROJECT NAME:

LOT 22 LIBBY HILL BUSINESS PARK 12 TROIANO WAY GARDINER, MAINE

CLIENT:

GARDINER TRANSFER COMPANY, LLC PO BOX 3541 PORTLAND, MAINE

SHEET TITLE:

PROPOSED BUILDING ELEVATIONS

SHEET NO:

A-101

